


All work to comply with current building regulations and codes of practice

Do not scale from drawings
all dimensions to be checked
on site before the start of
any work

A scale bar for a 1:100 scale map. It features a horizontal line with tick marks at 0, 1, 2, 5, and 10. The first two units are divided into smaller segments, while the remaining units are represented by solid gray rectangles. The text "1:100" is positioned to the left of the scale bar, and "10 Metres" is written at the far right end of the scale.

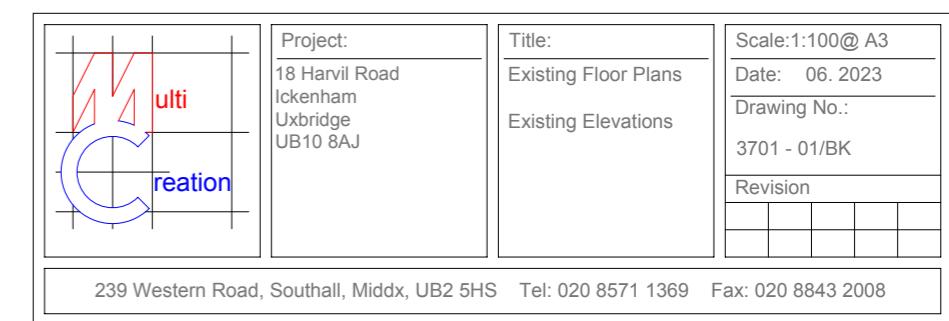



Existing Front Elevation
Scale:1:100



Existing Side Elevation
Scale:1:100



Existing Rear Elevation
Scale:1:100




Existing Side Elevation
Scale:1:100

All work to comply with
current building regulations
and codes of practice


Do not scale from drawings
all dimensions to be checked
on site before the start of
any work

1:100

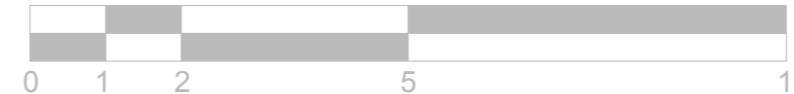

	Project:	18 Harvil Road Ickenham Uxbridge UB10 8AJ	Scale:1:100@ A3 Date: 06. 2023 Drawing No.: 3701 - 02/BK Revision <table border="1" style="width: 100px; height: 20px; border-collapse: collapse;"></table>
	Title:	Existing E elevations	
239 Western Road, Southall, Middx, UB2 5HS Tel: 020 8571 1369 Fax: 020 8843 2008			

**PROPOSED
GROUND FLOOR
PLAN**
1:50

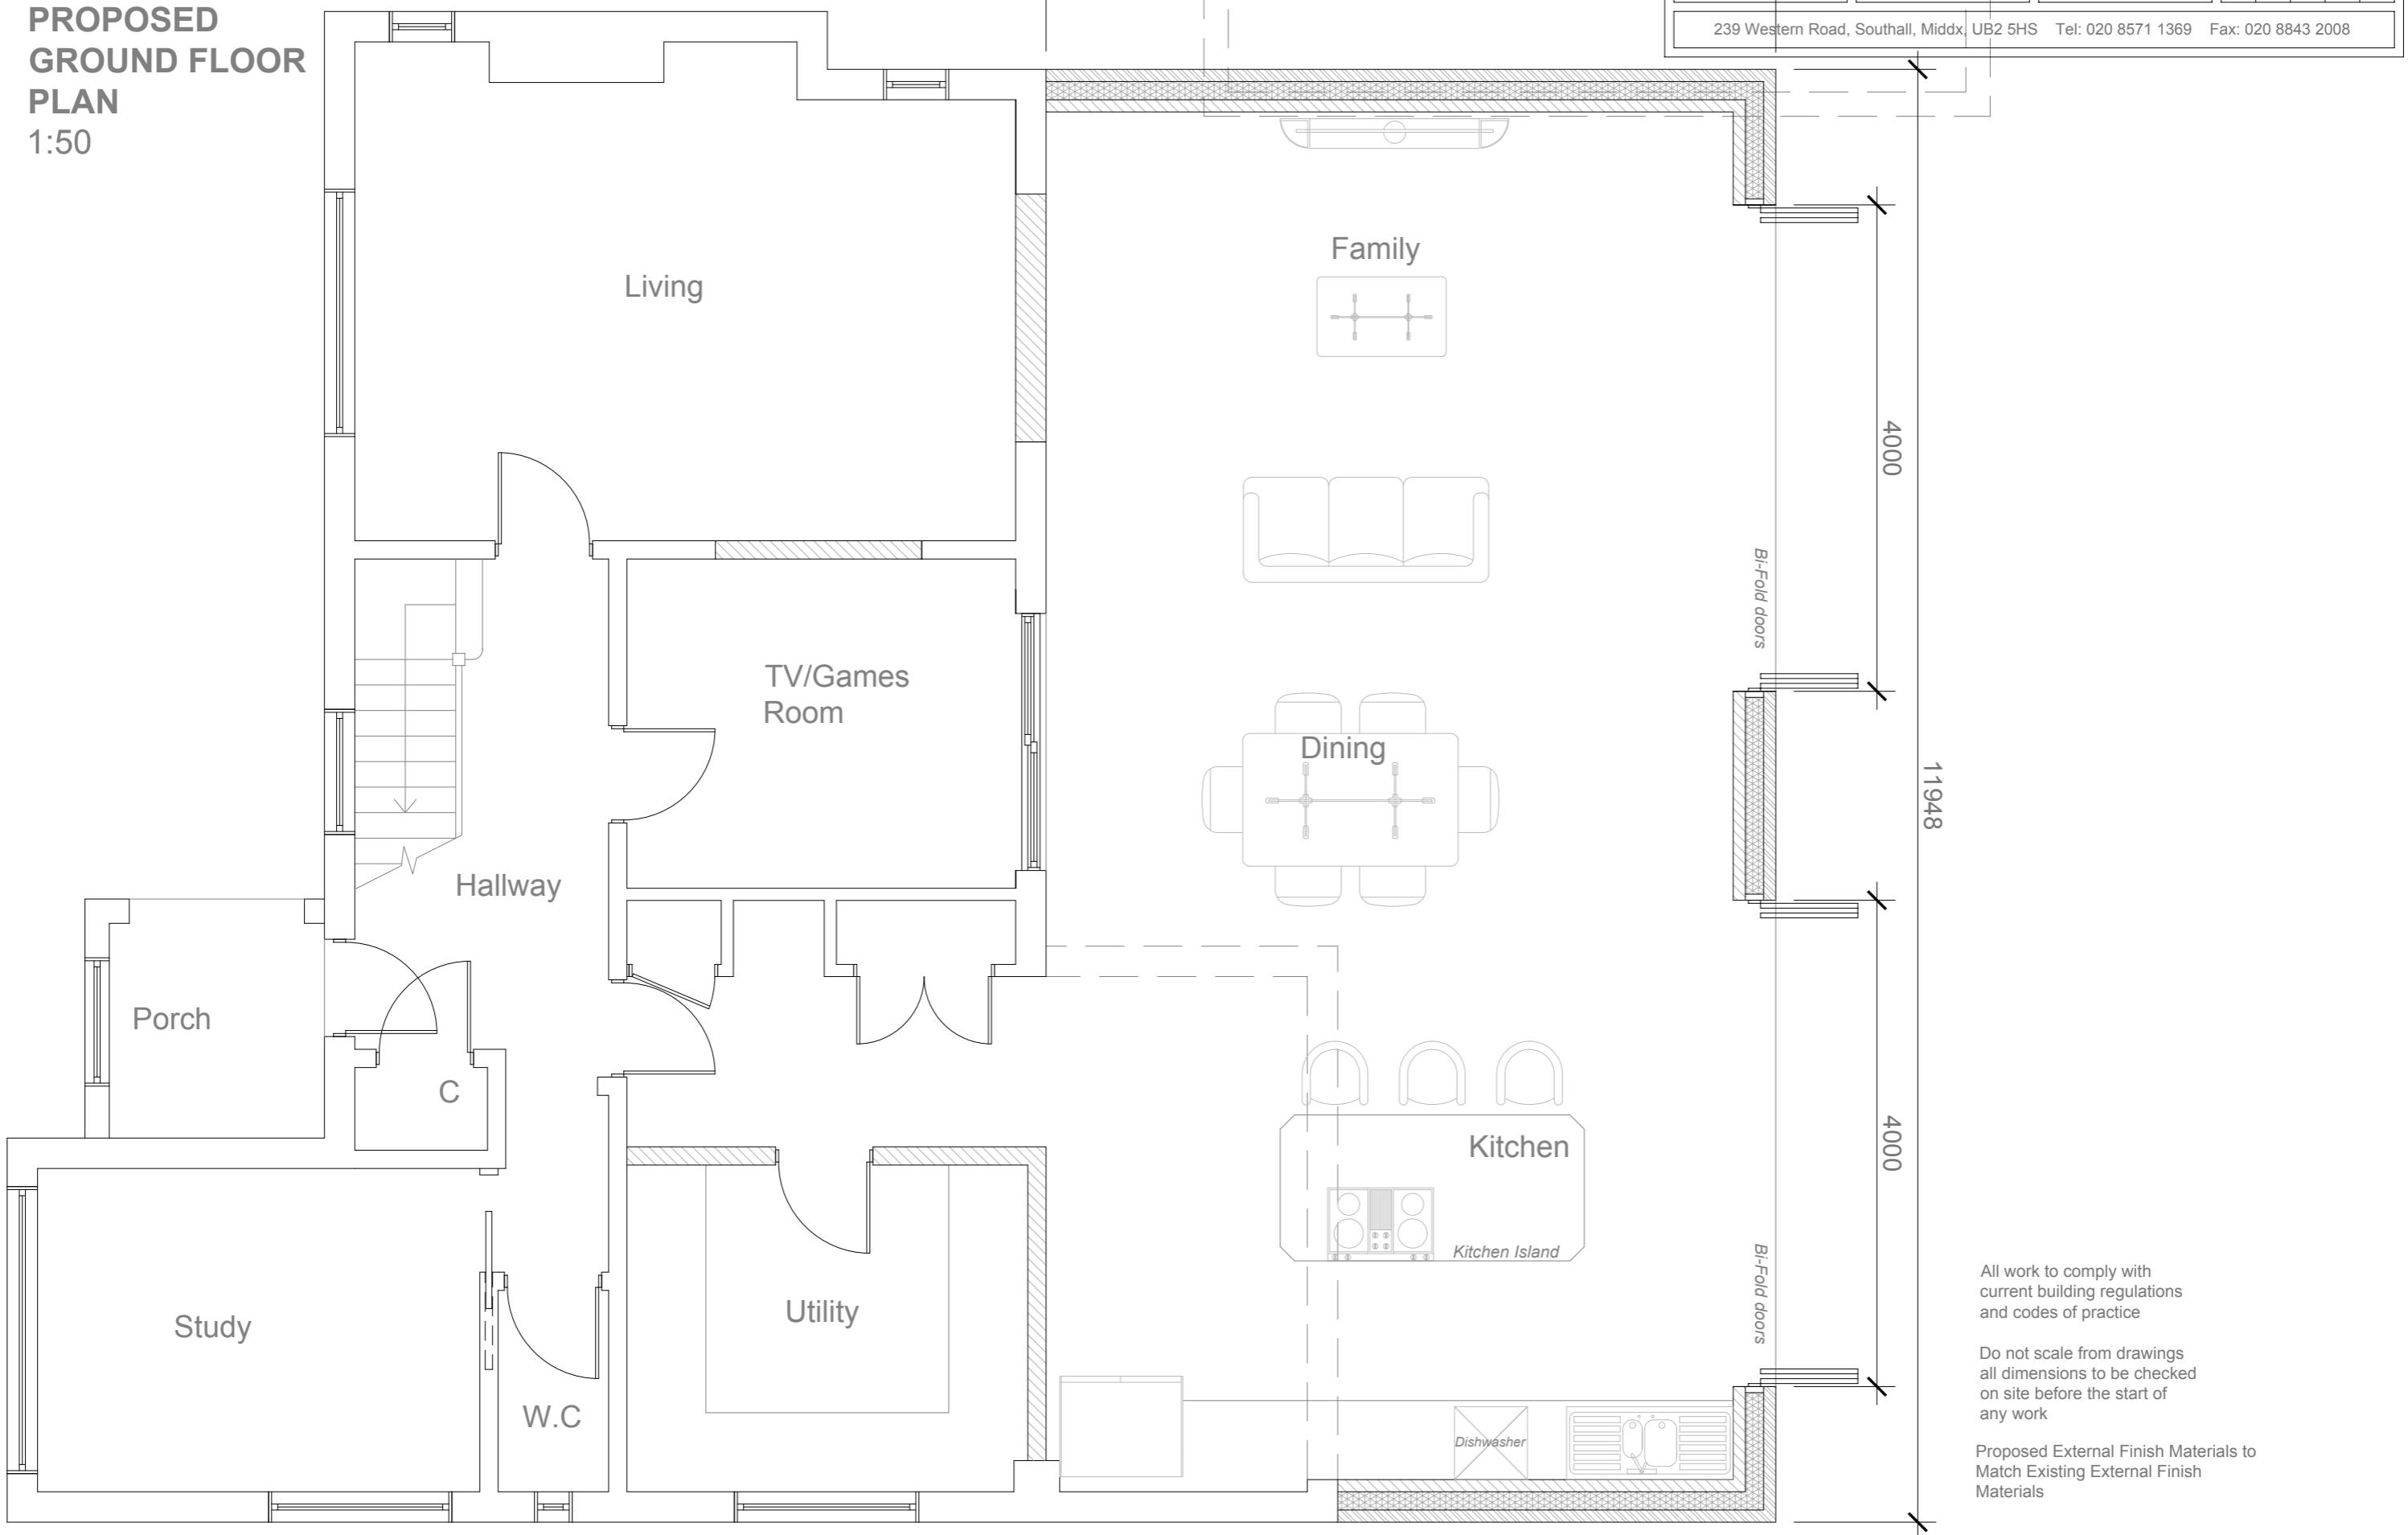



Front Elevation
Scale:1:100



Proposed Side Elevation
Scale:1:100



Proposed Rear Elevation
Scale:1:100



Proposed Side Elevation
Scale:1:100

All work to comply with
current building regulations
and codes of practice

Do not scale from drawings
all dimensions to be checked
on site before the start of
any work

1:100

0 1 2 5 10 Meter

	Project: 18 Harvil Road Ickenham Uxbridge UB10 8AJ	Title: Proposed Elevations	Scale:1:100@ A3
	Date: 06. 2023	Drawing No.:	3701 - 04/BK
	Revision		