





Existing Front Elevation
Scale 1:100




Existing Side Elevation
Scale 1:100

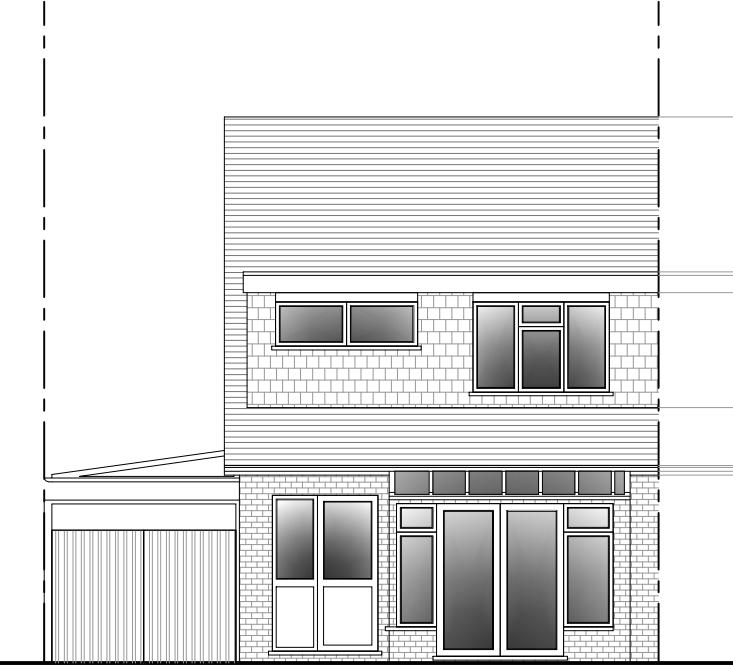


Existing Rear Elevation
Scale 1:100

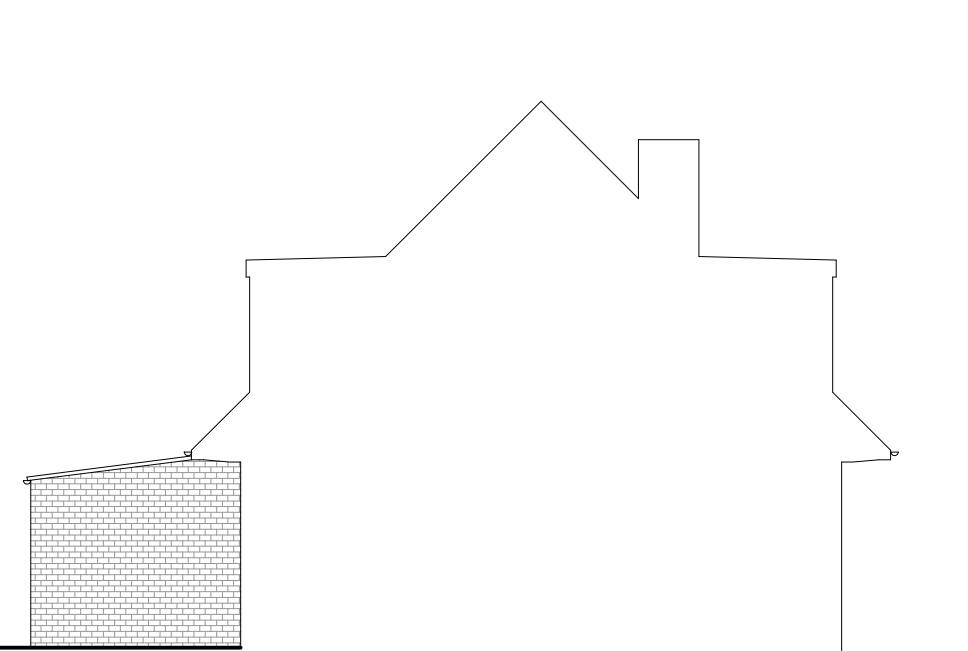

Existing Side Elevation
Scale 1:100

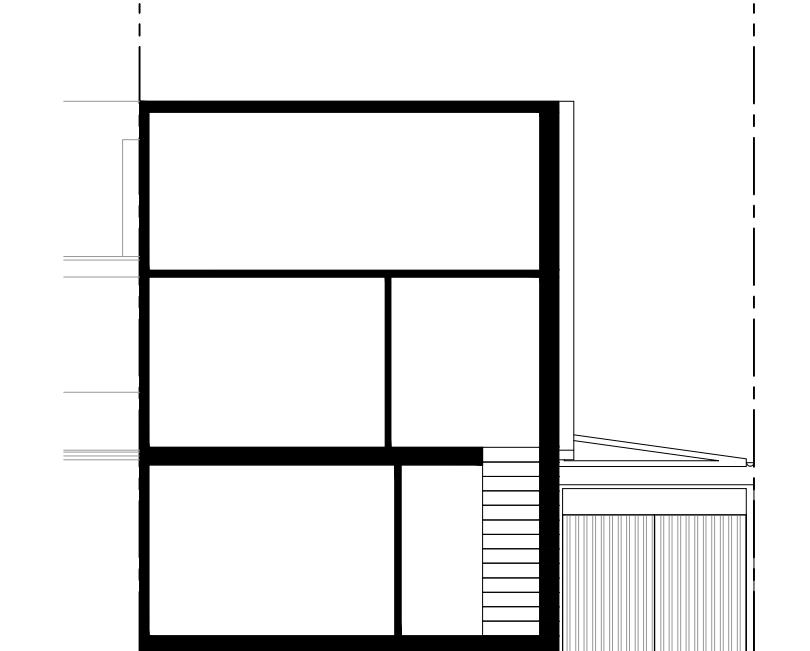

Existing Front Section
Scale 1:100

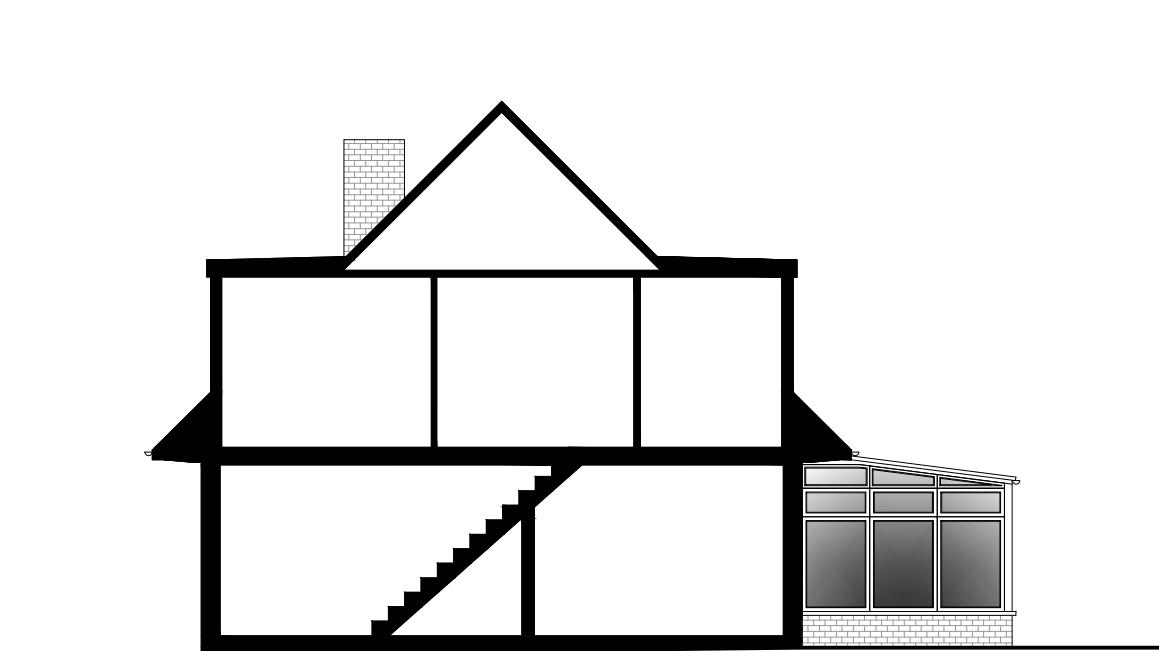

Existing Side Section
Scale 1:100

PARTY WALL ACT 1996
OWNER/S MUST ENSURE ALL
PARTY WALL AGREEMENTS ARE
IN PLACE FOR ANY BUILDINGS
WORKS ARE TO COMMENCE

Please note that construction must only commence once planning, building control and any other approvals have been received. It is the responsibility of the owner/contractor to commence prior to these approvals.

0 1 2 3 4 5

10m



Legend

Walls Removed	
New Walls	
Existing Walls to Remain	
Roof Structure	
Sound Separating Walls	
Boundary	

IMPORTANT GENERAL NOTE
The specification is to be read in conjunction with the plans/section details, and other associated Structural details as may be provided.
All work is to be carried out to the Local Authority Planning and Building Regulations Approval, and the Code of Practice and British Standards as necessary.
All dimensions, levels, sizes, positions and locations of particulars as indicated on drawings are to be verified by the appointed Contractor on site prior to engaging in works. Any discrepancies must be reported to the Architect/Surveyor/Engineer or responsible person/s immediately.
The Contractor is responsible for ensuring compliance with the CDM Regulations, and appropriate Health & Safety on site precautions.
The Client/Building Owner must obtain any necessary PARTY WALL AGREEMENTS, prior to engaging in the works on site.

Revision	Date	Description	Paper Size	Scale	Construct 360 Ltd, Trading as:
				1:100	DontMoveExtend.com
				Revision	info@DontMoveExtend.com
				1st	Tel: 0208 206 0011
				Feb-20	Site Address
					29 Wyteleaf Close
					Ruislip
					HA4 7SP
					Existing Elevations & Sections
					Drawing Number
					WC29-02-1002
					DontMoveExtend.com and the Red Box are Registered Trade Marks Of Construct 360 Ltd

A3

Drawn By NE

AP

Checked By

Status

Planning Issue