





No. 62  
Existing Front Elevation  
Scale 1:100




No. 58  
Existing Rear Elevation  
Scale 1:100

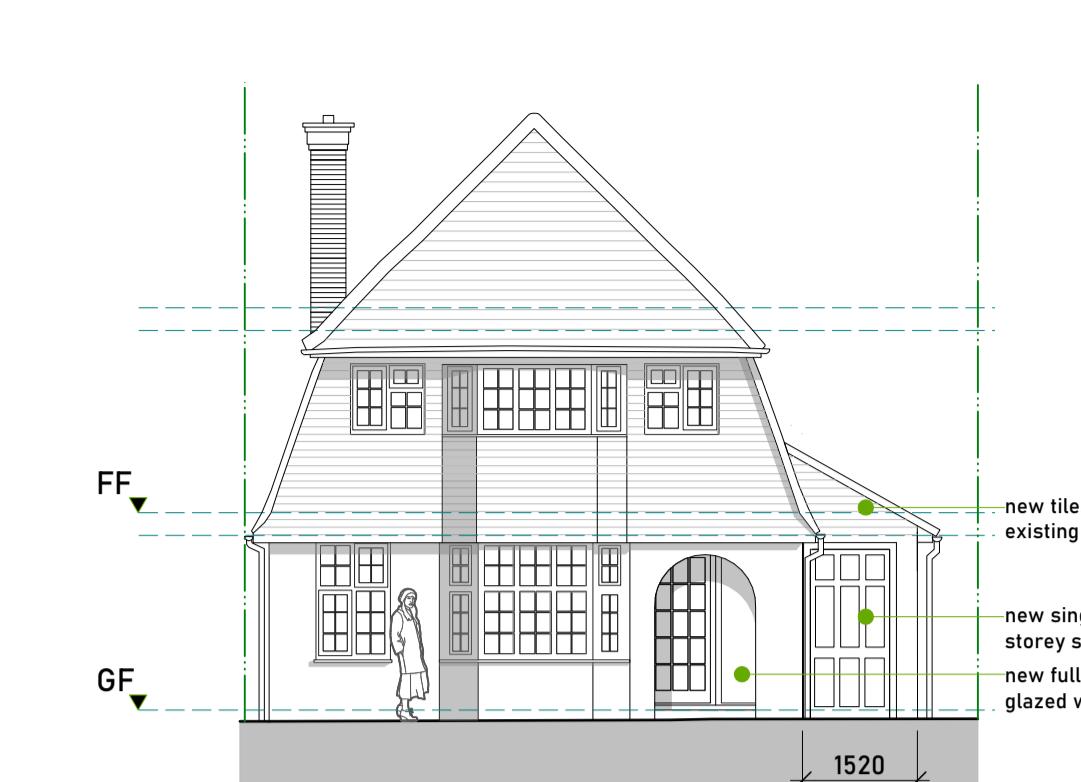


No. 62  
Proposed Front Elevation  
Scale 1:100

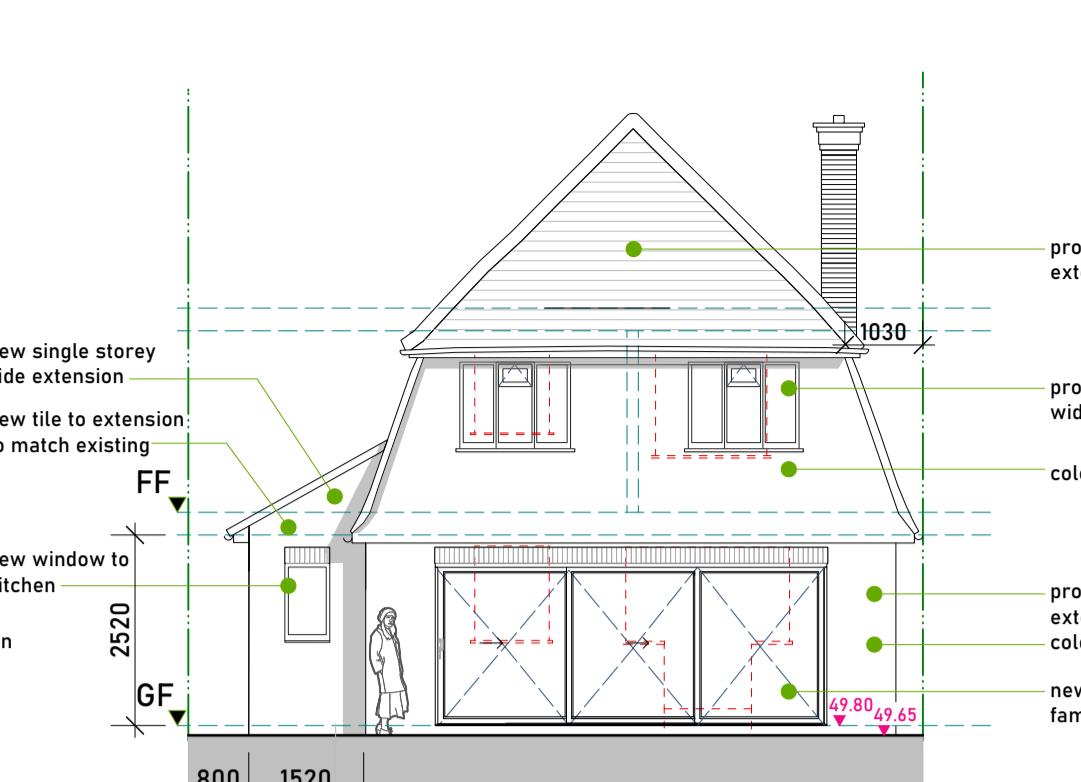


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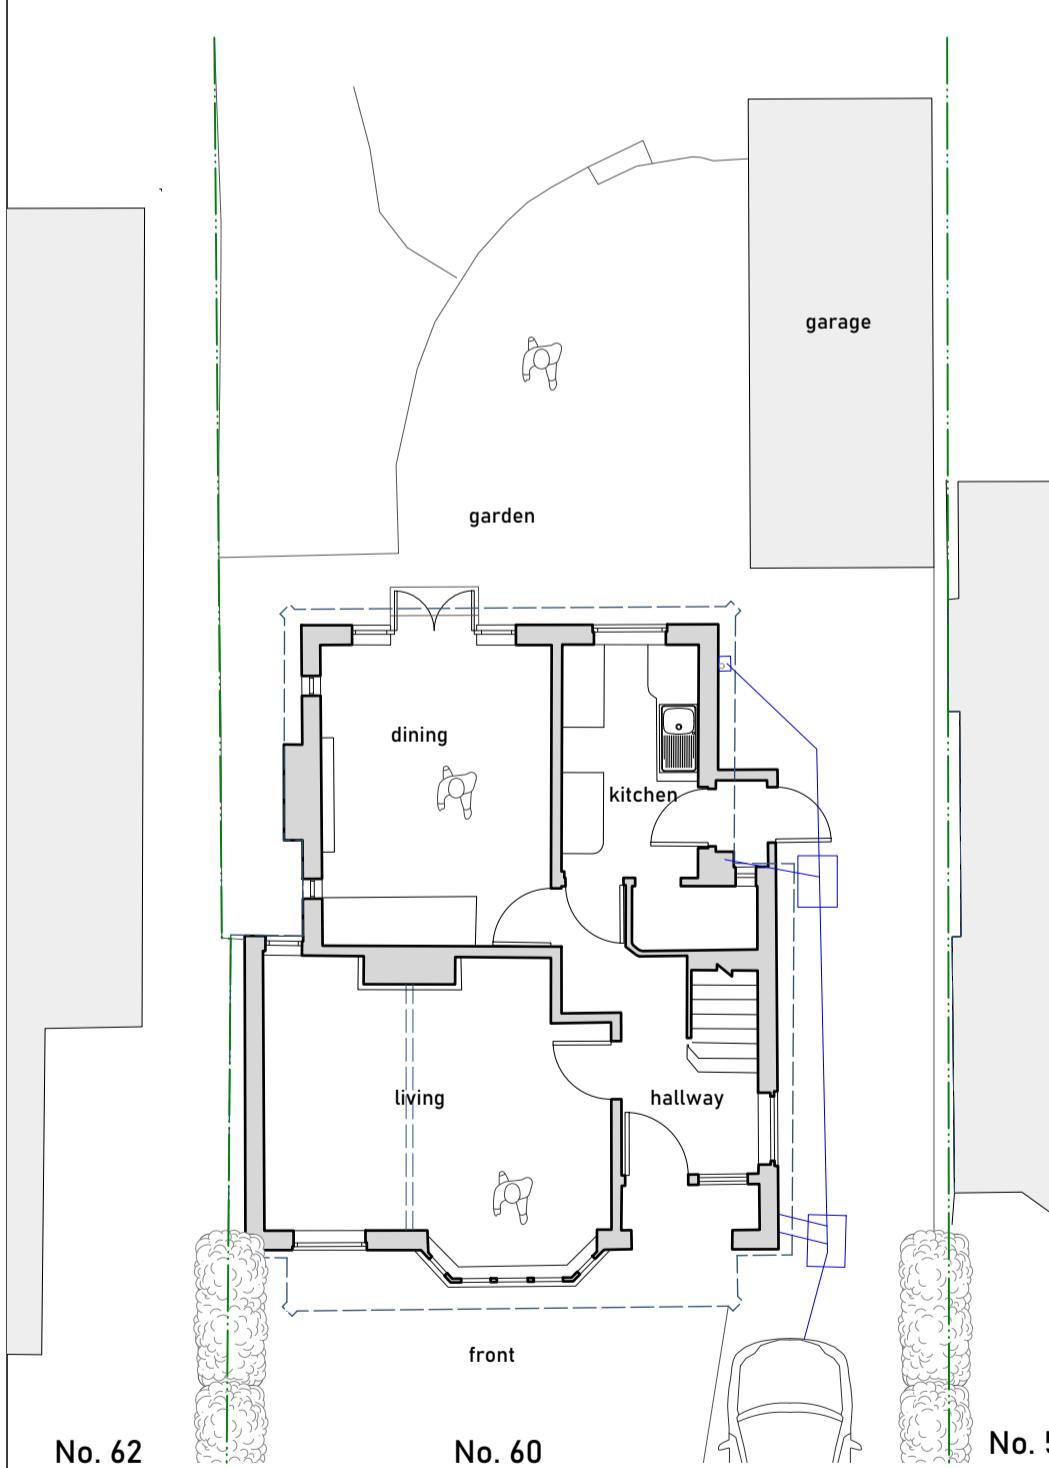
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Proposed Side Elevation  
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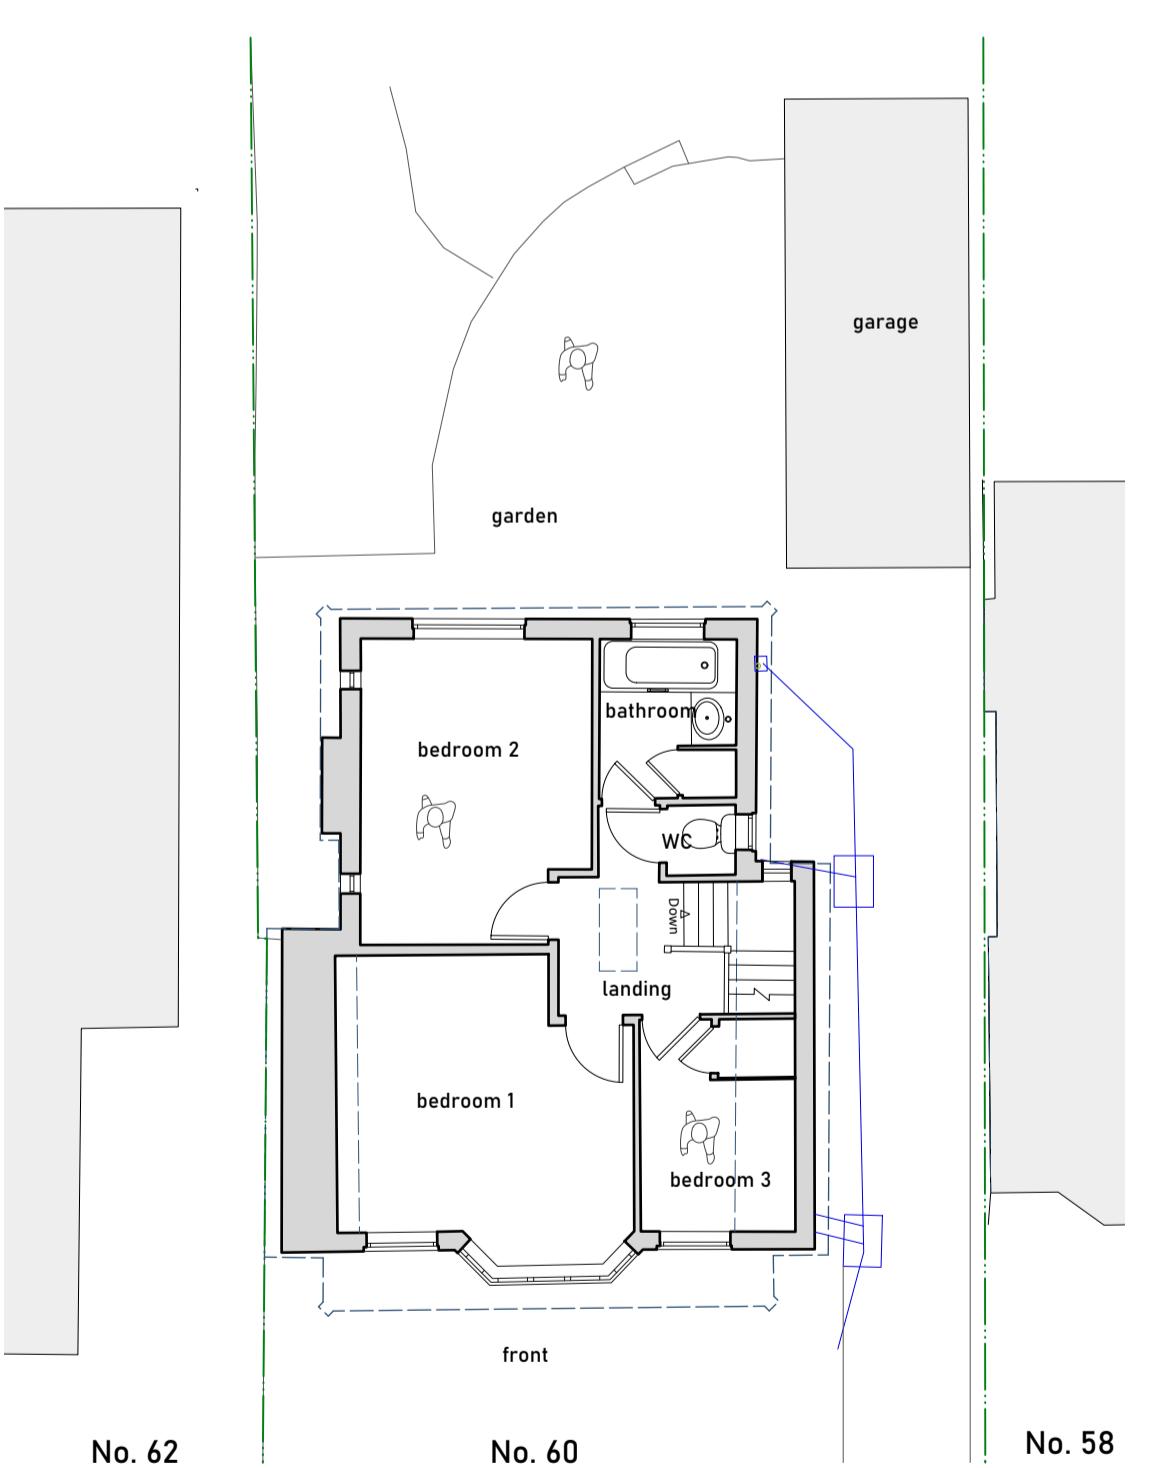
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Existing Side Elevation  
Scale 1:100

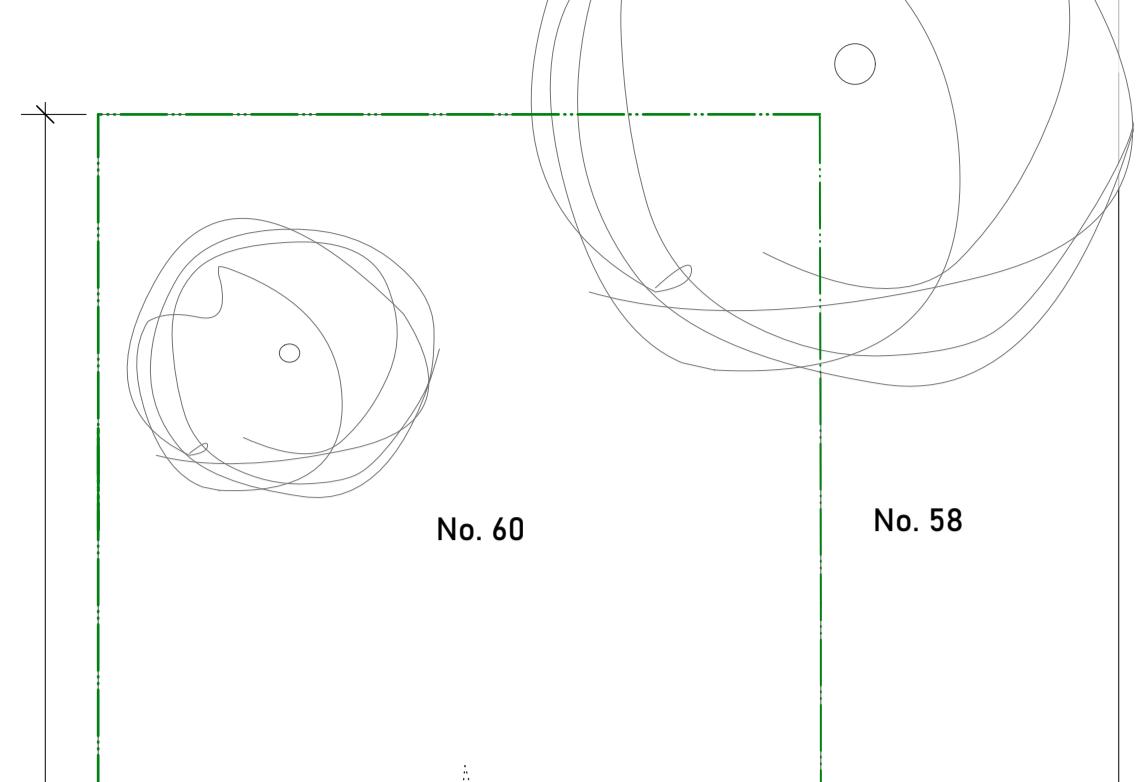


No. 58  
Proposed Side Elevation  
Scale 1:100

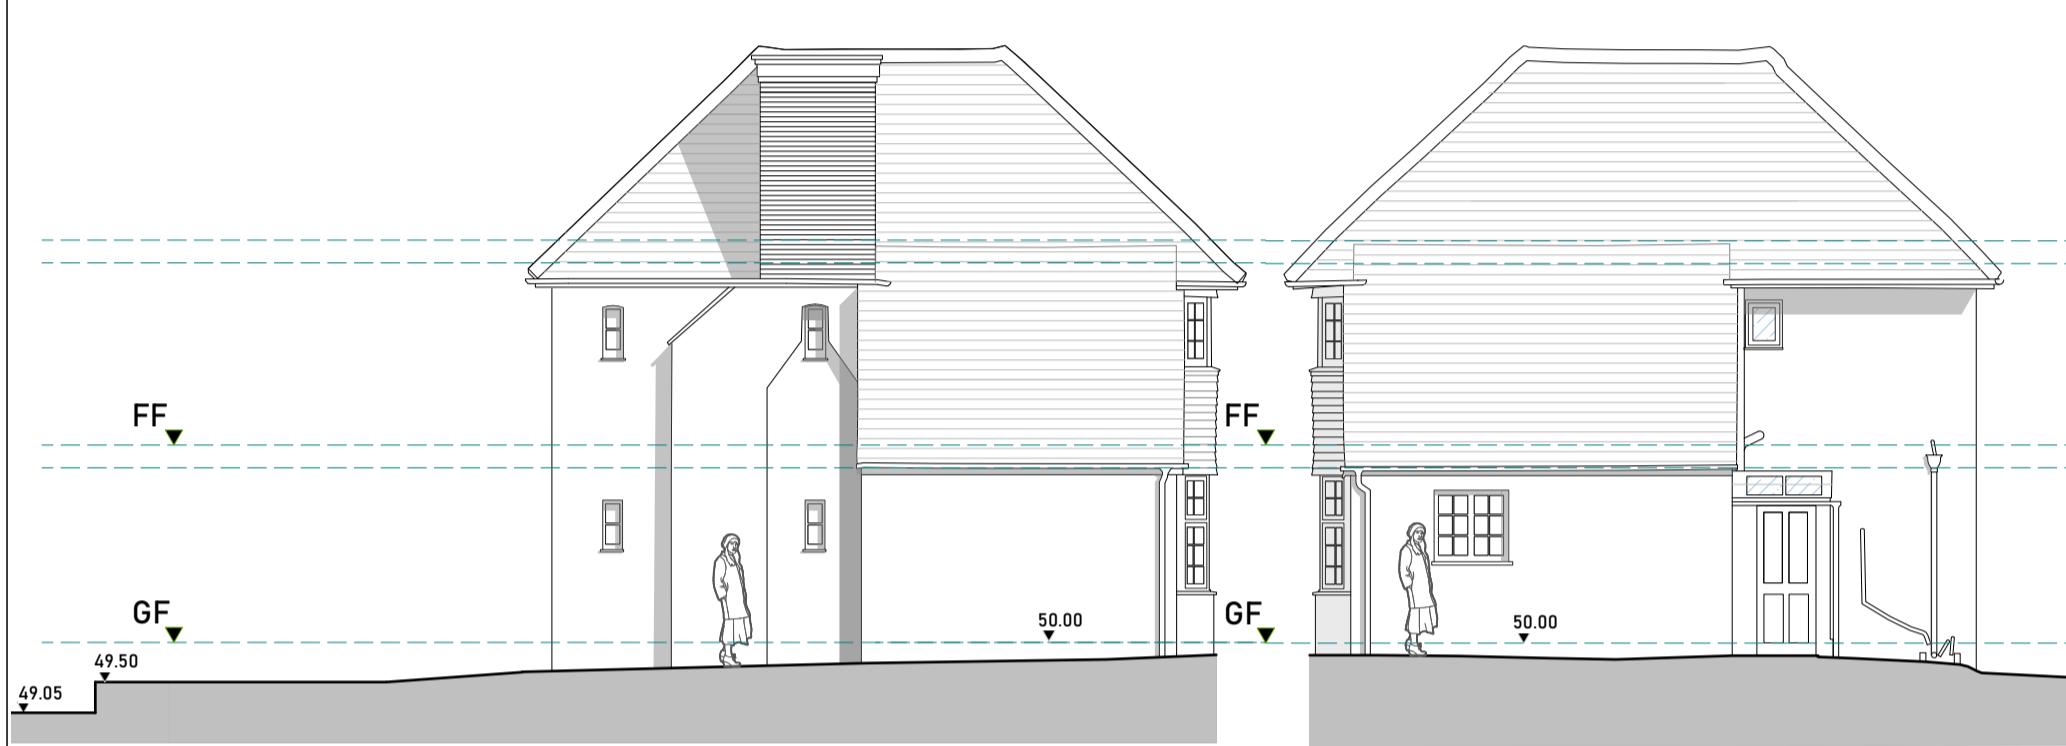


No. 62  
No. 60  
No. 58  
Existing Ground Floor Plan  
Scale 1:100

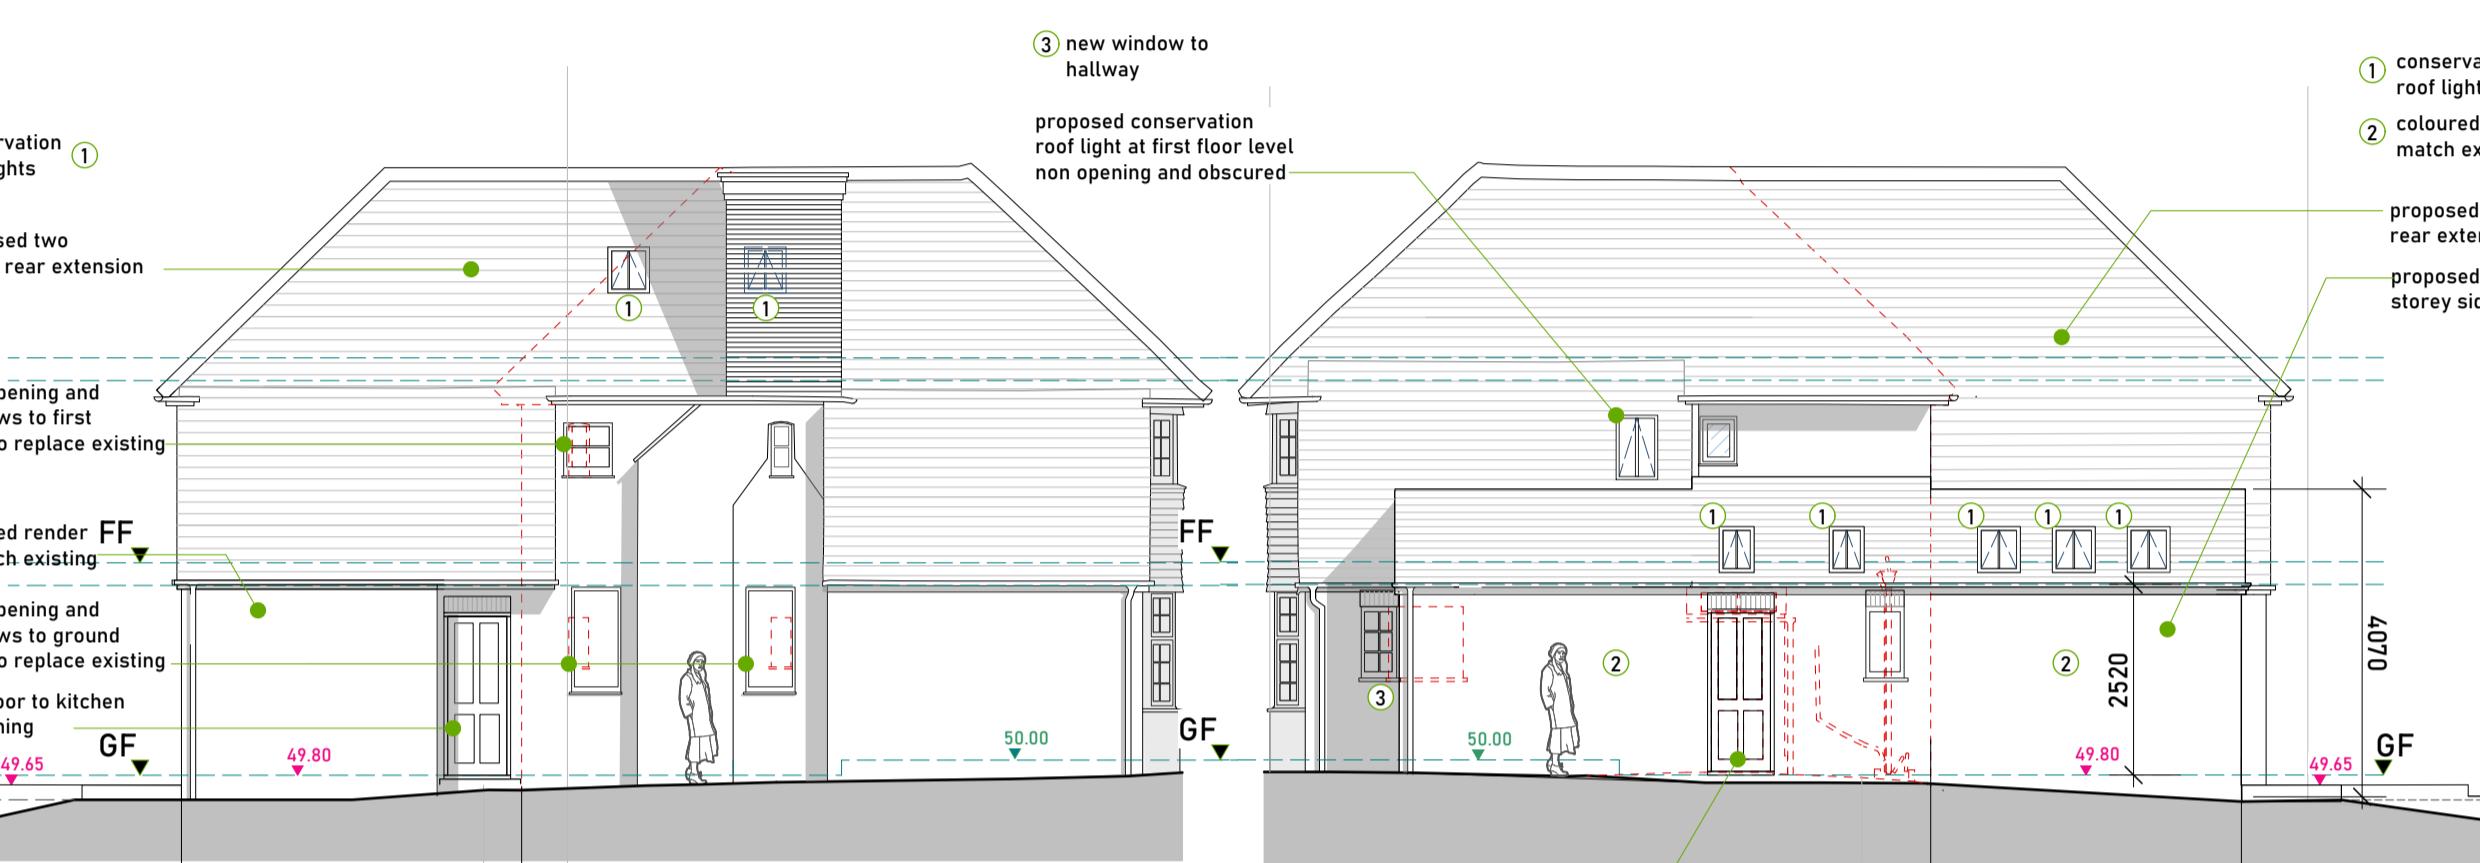


No. 62  
No. 60  
No. 58  
Existing First Floor Plan  
Scale 1:100

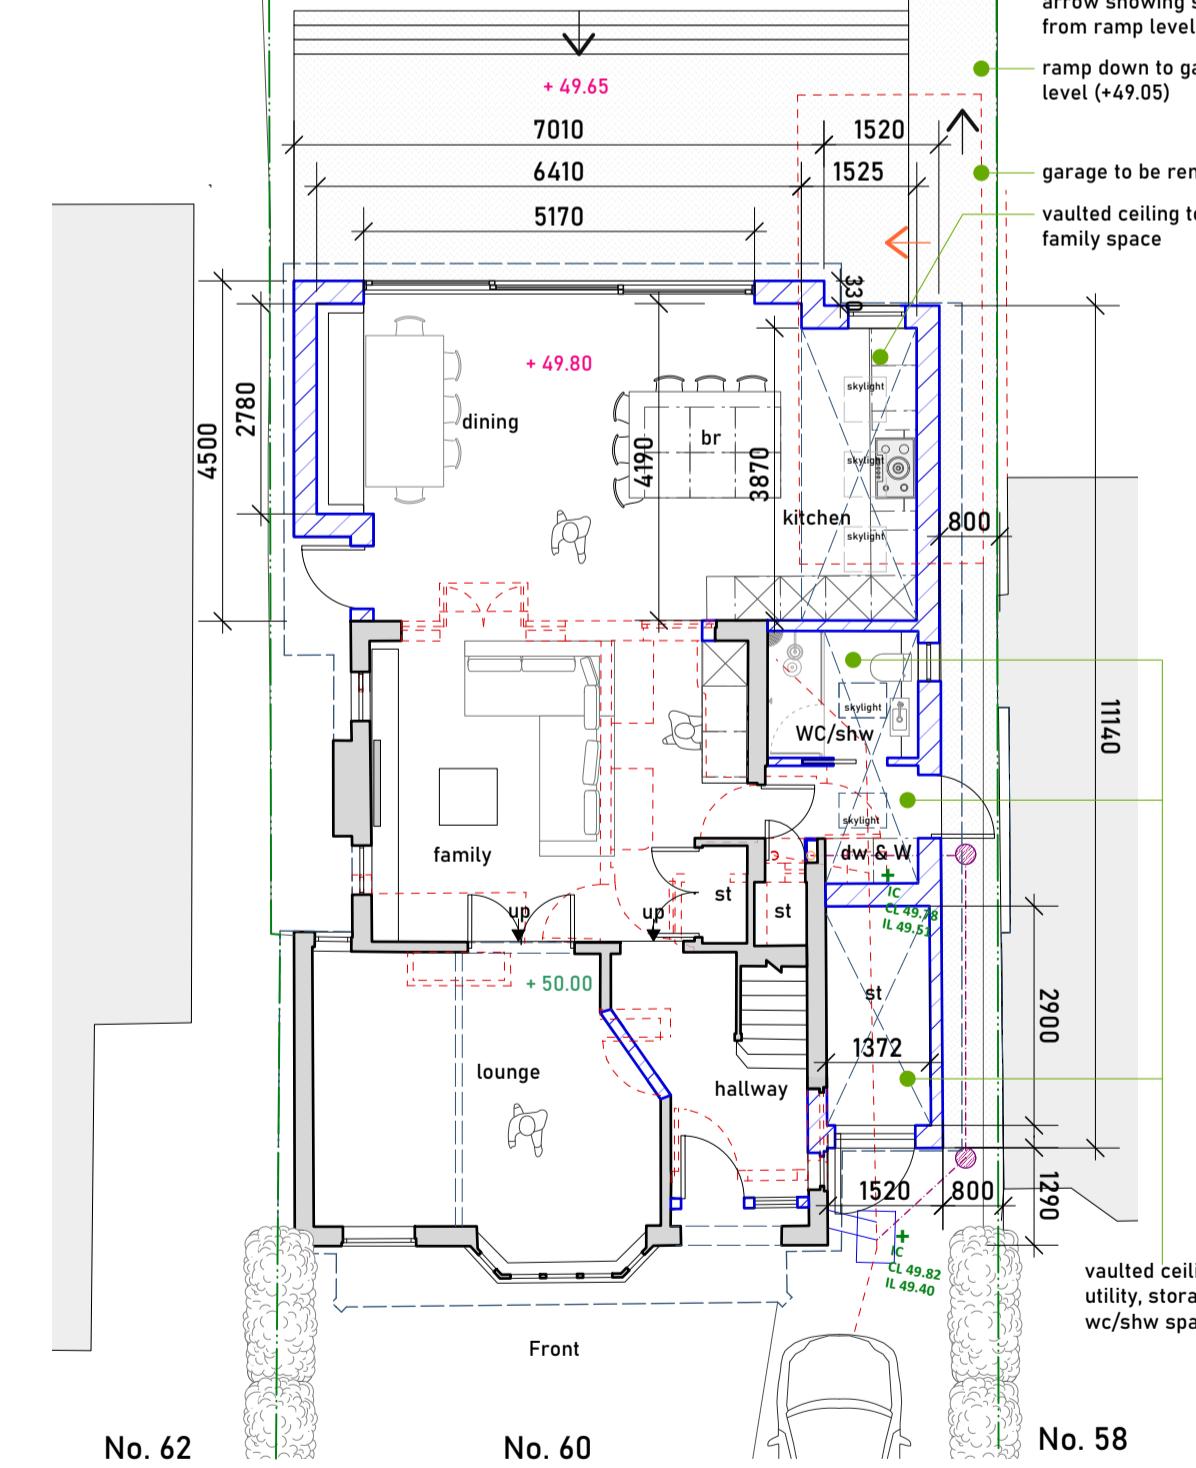

No. 62  
No. 60  
No. 58  
Proposed Ground Floor Plan  
Scale 1:100

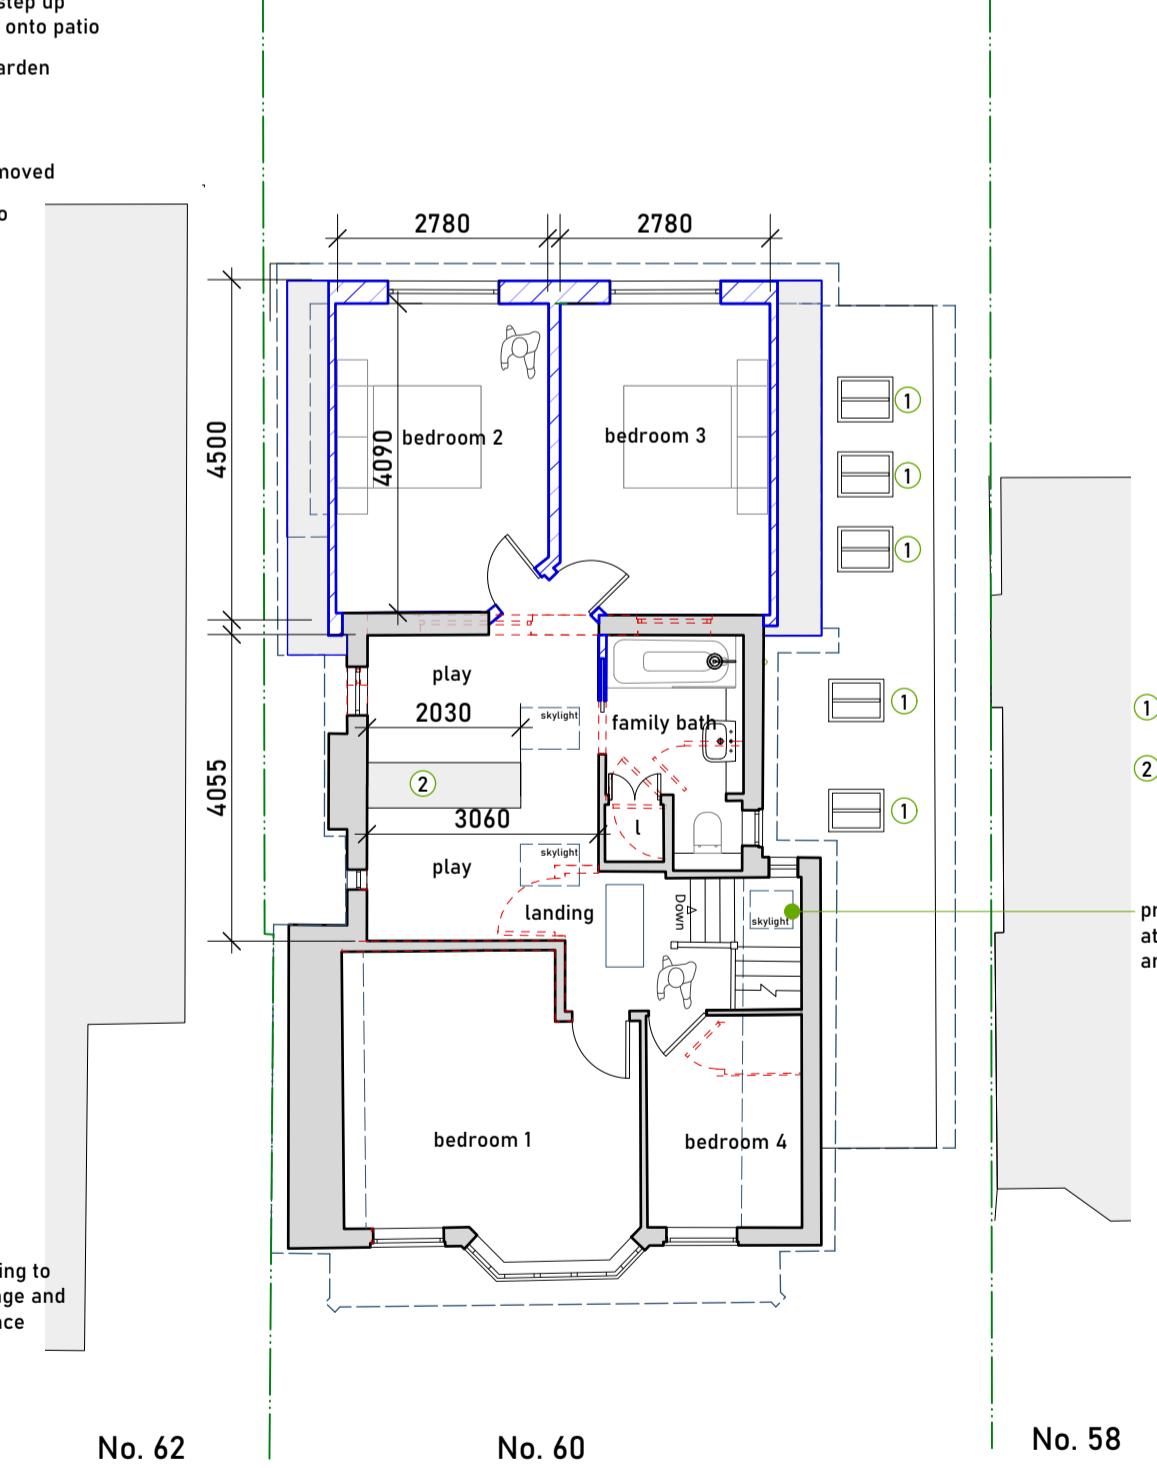

No. 62  
No. 60  
No. 58  
Proposed First Floor Plan  
Scale 1:100

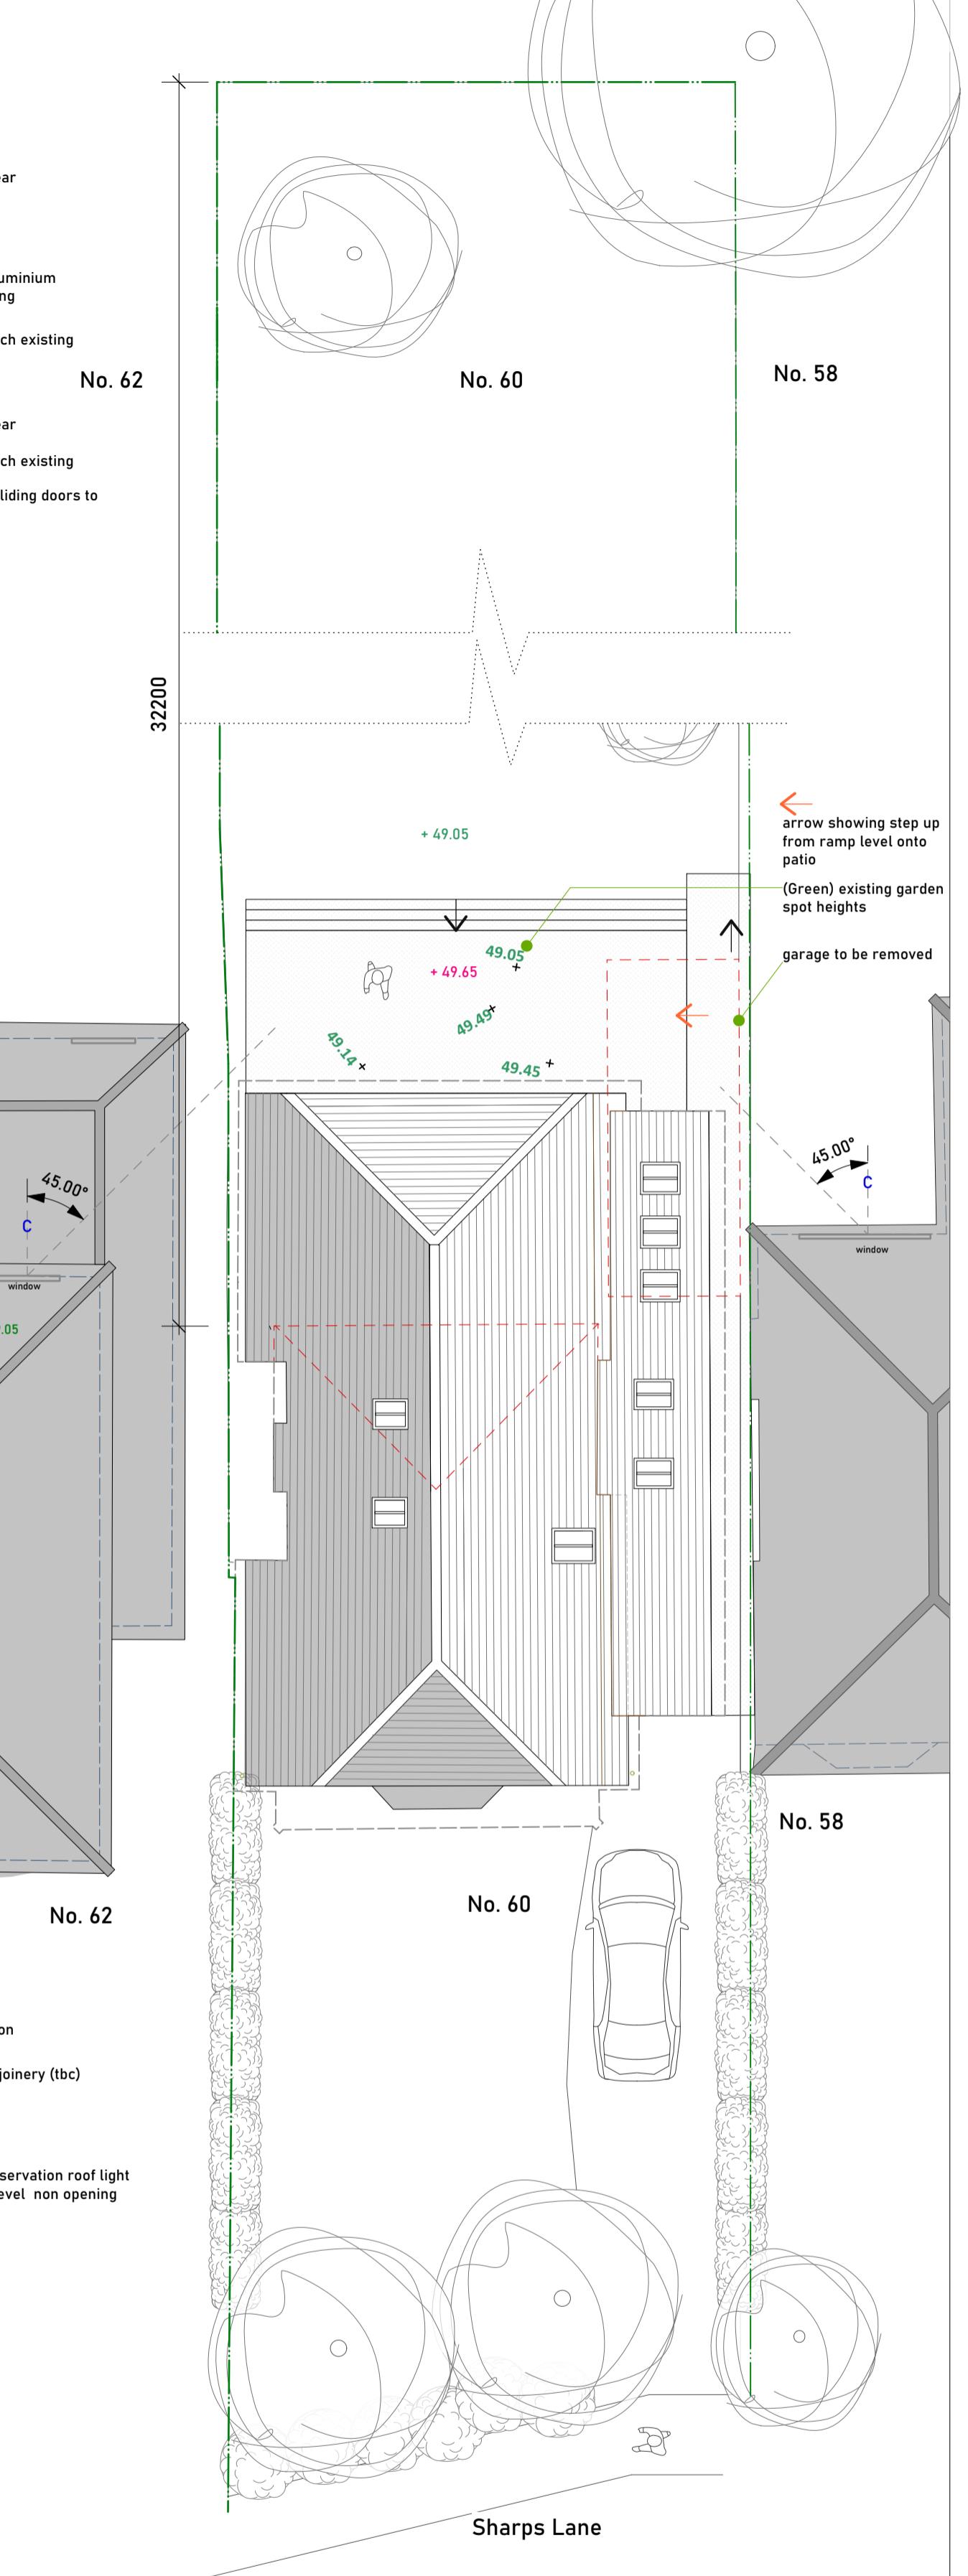

No. 60  
No. 58  
Proposed Site Plan  
Scale 1:100

DRAWING NOTES:  
All dimensions to be checked on site prior to commencement of any works, and/or preparation of any shop drawings.  
Sizes and dimensions of any structural elements are indicative only. See structural engineers drawings for actual sizes/dimensions.  
Sizes of and dimensions to any service elements are indicative only. See service engineers drawings for actual sizes and dimensions.  
This drawing to be read in conjunction with all other Architect's drawings, specifications and other Consultants' information.  
All proprietary systems shown on this drawing are to be installed strictly in accordance with the Manufacturers/Suppliers recommended details.  
Any discrepancies between information shown on this drawing and any other contract information or manufacturers/suppliers recommendations is to be brought to the attention of the Architect.  
DO NOT SCALE FROM THIS DRAWING.

DRAWING NOTES:  
- Site Boundary  
- Proposed Walls  
- Floor and ceiling levels  
- Demolished  
+ existing site level  
+ new level

Rev C - 12/04/2022 - Client Comments  
Rev B - 31/03/2022 - Client Comments  
Rev A - 22/03/2022 - Client Comments  
STATUS REVISION  
DATE

60 Sharps Lane Drawings  
SCALE 1:100 @ A1 1:200 @ A3 CHECKED BY JD  
DATE 23/03/22 DRAWN BY OAK  
DWG No. 605-P-1-C REVISION C  
DRAWING STATUS PLANNING  
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Jack Dušek & Co.  
CLIENT Sonia & Rients Jan Veldkamp  
PROJECT 60 Sharps Lane, Ruislip, HA4 7JQ