



Existing Ground Floor Plan
Scale 1:100




Existing First Floor Plan
Scale 1:100

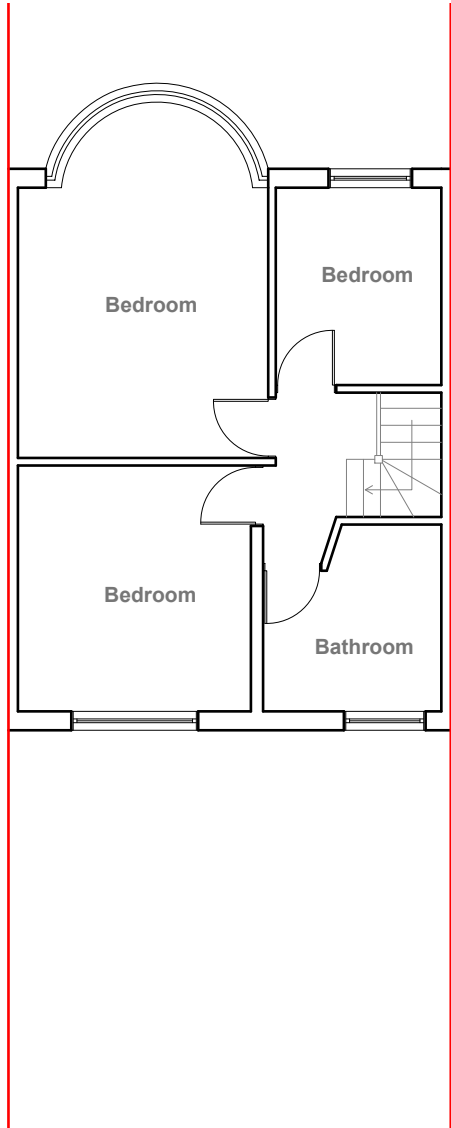


Existing Front Elevation
Scale 1:100

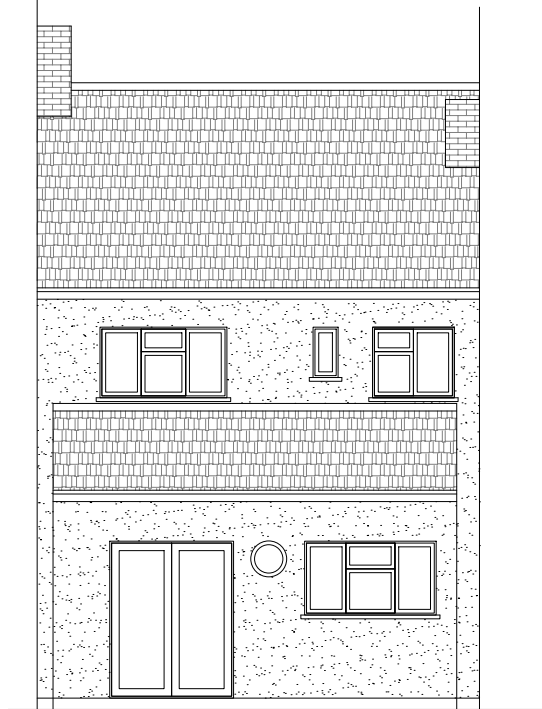

Existing Rear Elevation
Scale 1:100

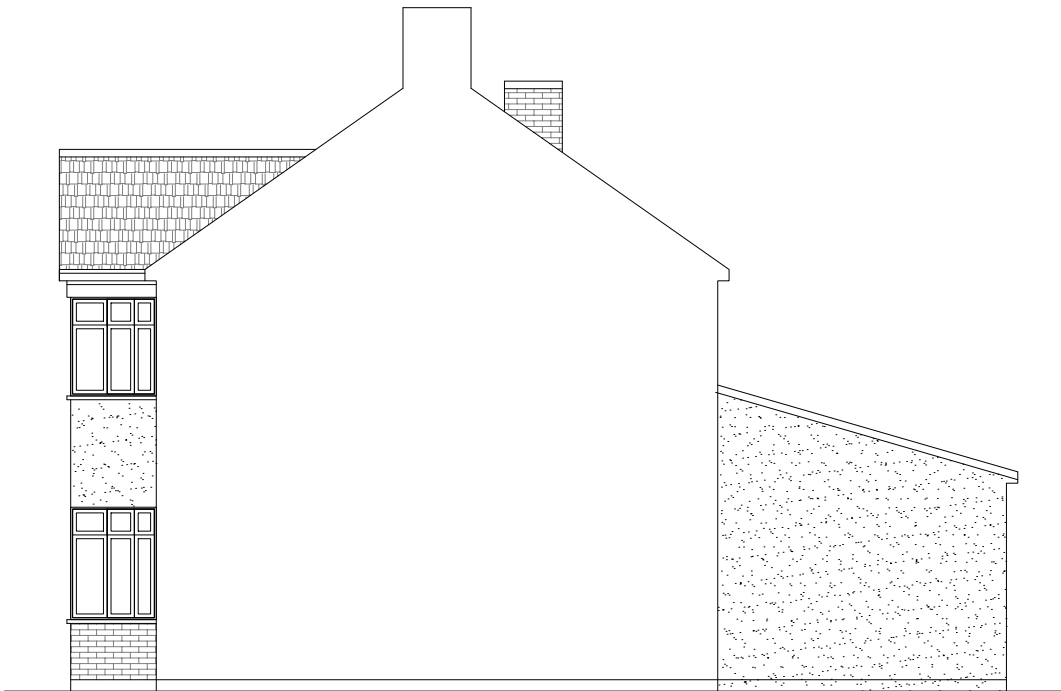

Existing Side Elevation
Scale 1:100

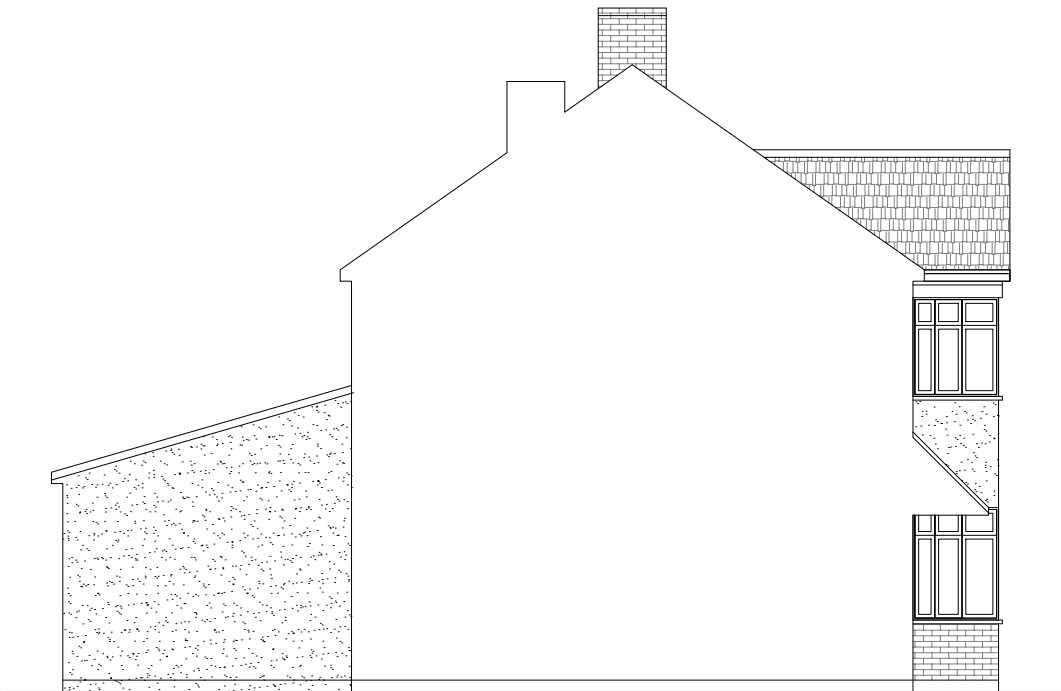

Existing Side Elevation
Scale 1:100



GENERAL NOTES:
1. ALL DIMENSIONS ARE IN MILLIMETER.
2. VERIFY ALL DIMENSIONS AND CONDITIONS BEFORE BUILDING OR STARTING CONSTRUCTION. NOTIFY THE DESIGNER IMMEDIATELY OF ANY DISCREPANCY OR VARIATION.
3. ALL WORK TO COMPLY WITH CURRENT BUILDING REGULATIONS AND CODES OF PRACTICE

Title:

Existing Floor Plans & Elevations


Site Address
80 Cornwall Road,
Ruislip,
Middlesex
HA4 6AN

Scale: 1:100 @A3
Date: 28/04/2021
Drawing No.:
2021/64 -01
Drawn By:
DP

Revision Date:

e:mail -
faluckpatel@yahoo.com
(M) +44 (0) 7871 466 254


Faluck
Patel

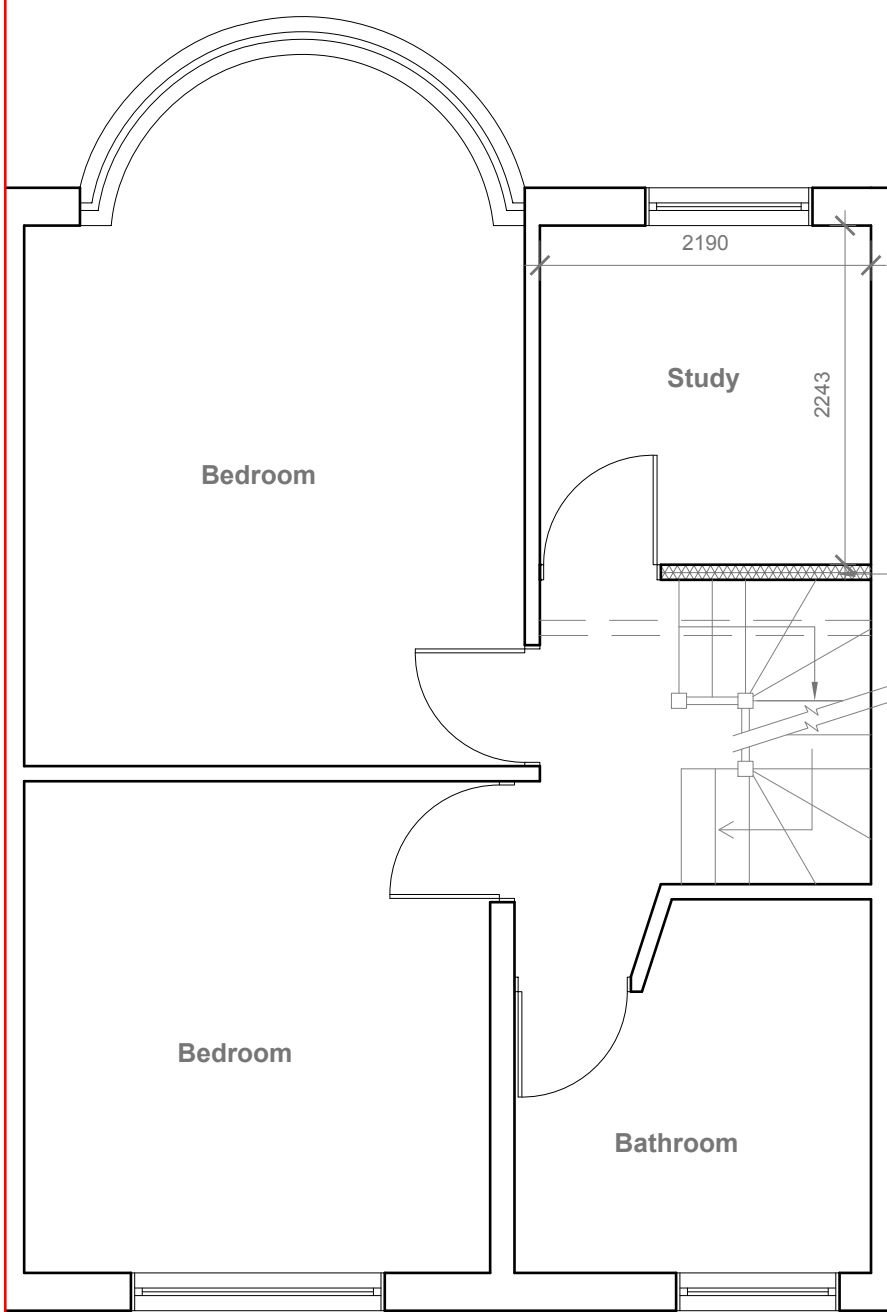

Proposed First Floor Plan

Scale 1:50

provide 2m headheight
between two Staircases (If not Exsiting Wall to be moved to get 2m clear headheight)

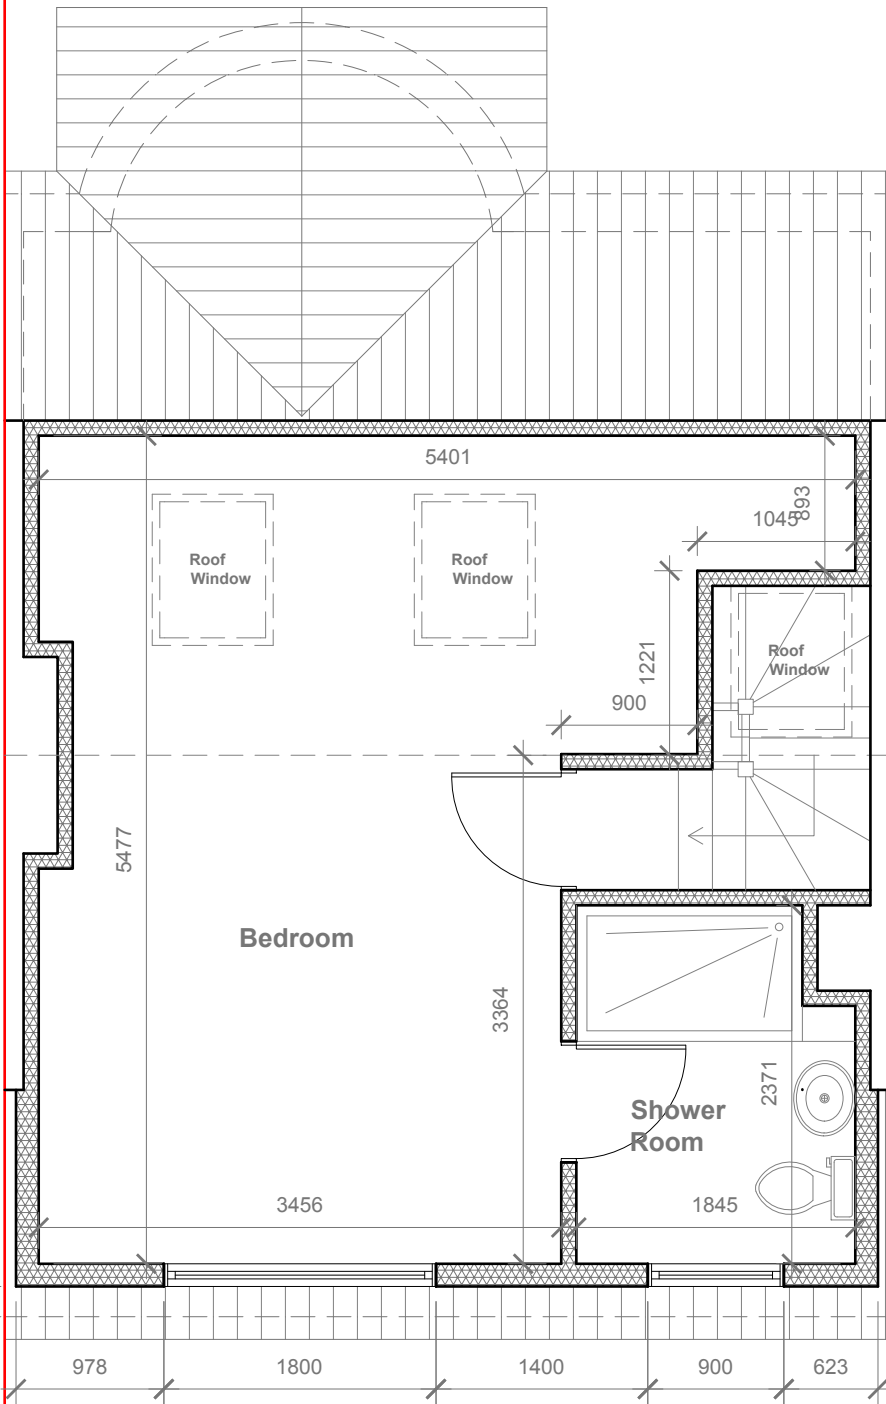

Proposed Loft Floor Plan

Scale 1:50

Velux Window to be installed as per manufacturer specification, not projected more than 150mm from the plane of roof slop



GENERAL NOTES:
1. ALL DIMENSIONS ARE IN MILLIMETER.
2. VERIFY ALL DIMENSIONS AND CONDITIONS BEFORE BUILDING OR STARTING CONSTRUCTION. NOTIFY THE DESIGNER IMMEDIATELY OF ANY DISCREPANCY OR VARIATION.
3. ALL WORK TO COMPLY WITH CURRENT BUILDING REGULATIONS AND CODES OF PRACTICE

Title:

Proposed First Floor & Loft Plans

Site Address

80 Cornwall Road,
Ruislip,
Middlesex
HA4 6AN

Scale: 1:50 @A3

Date: 28/04/2021

Drawing No.:
2021/64 -02

Drawn By:
DP


Revision Date:

e:mail -
faluckpatel@yahoo.com
(M) +44 (0) 7871 466 254

**Faluck
Patel**




Proposed Front Elevation
Scale 1:100

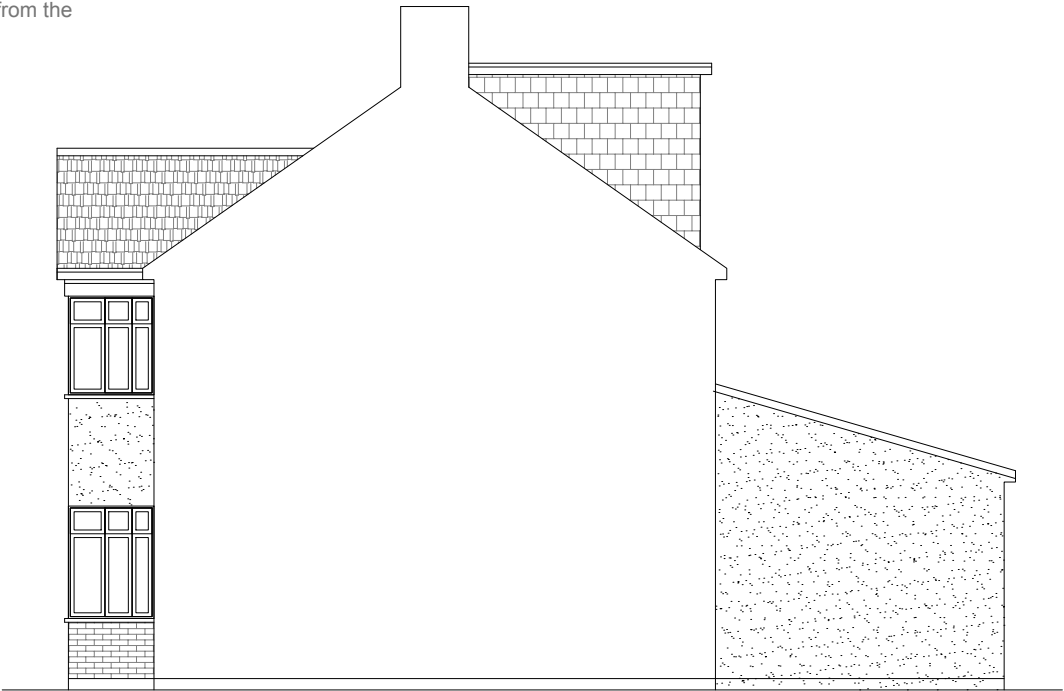

Proposed Side Elevation
Scale 1:100



Proposed Rear Elevation
Scale 1:100

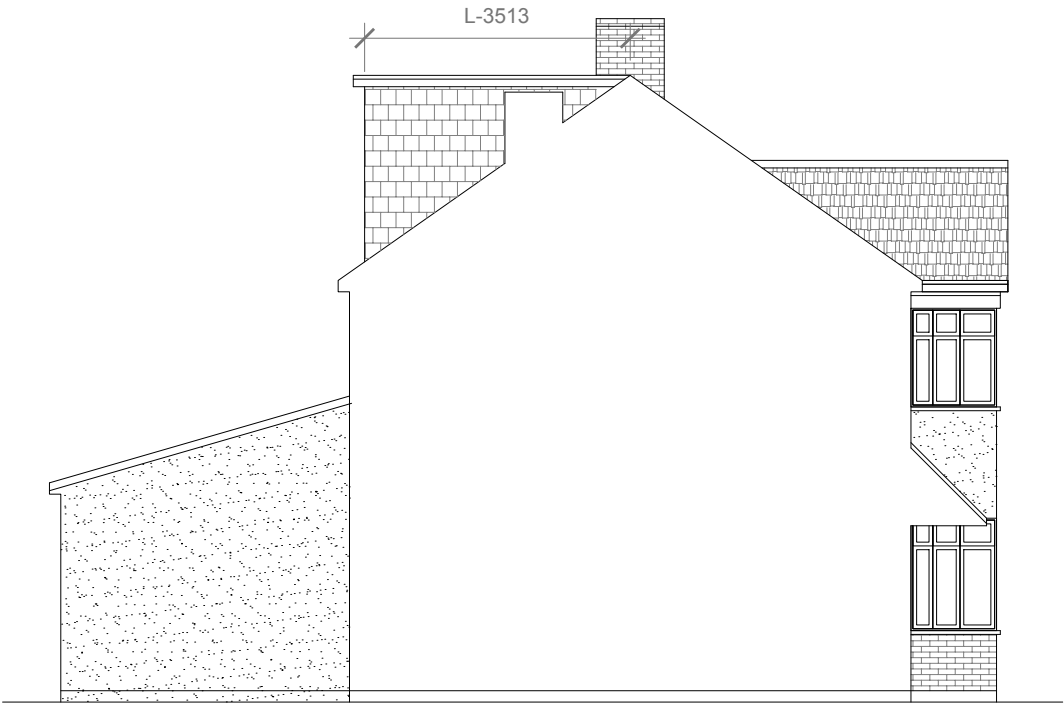

Proposed Side Elevation
Scale 1:100

REAR DORMER VOLUME = $W \times H \times L / 2$
 $5.701 \times 2.467 \times 3.513 / 2$
 $49.40 / 2$
V1 = $24.70 \text{ CU.MT.} > 40 \text{ CU.MT.}$

Proposed External Finish
Materials to Match Existing
External Finish Materials



GENERAL NOTES:
1. ALL DIMENSIONS ARE IN MILLIMETER.
2. VERIFY ALL DIMENSIONS AND CONDITIONS BEFORE BUILDING OR STARTING CONSTRUCTION. NOTIFY THE DESIGNER IMMEDIATELY OF ANY DISCREPANCY OR VARIATION.
3. ALL WORK TO COMPLY WITH CURRENT BUILDING REGULATIONS AND CODES OF PRACTICE

Title:

Proposed Elevations

Site Address	Scale: 1:100 @A3	Revision Date:
80 Cornwall Road, Ruislip, Middlesex HA4 6AN	Date: 28/04/2021	
	Drawing No.: 2021/64 -03	
	Drawn By: DP	e:mail - faluckpatel@yahoo.com (M) +44 (0) 7871 466 254

