

10 Meter
5
2
1
0
1:100

GENERAL NOTES:
 1. ALL DIMENSIONS ARE IN MILLIMETER.
 2. VERIFY ALL DIMENSIONS AND CONDITIONS BEFORE BUILDING OR
 STARTING CONSTRUCTION. NOTIFY THE DESIGNER IMMEDIATELY OF ANY
 DISCREPANCY OR VARIATION.
 3. ALL WORK TO COMPLY WITH CURRENT BUILDING REGULATIONS
 AND CODES OF PRACTICE

Title:

Existing Floor Plans & Elevations



Site Address
80 Cornwall Road,
Ruislip,
Middlesex
HA4 6AN

Scale: 1:100 @A3
Date: 28/04/2021
Drawing No.: 2021/64 -01
Drawn By: DP

Revision Date:

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Faluck
Patel

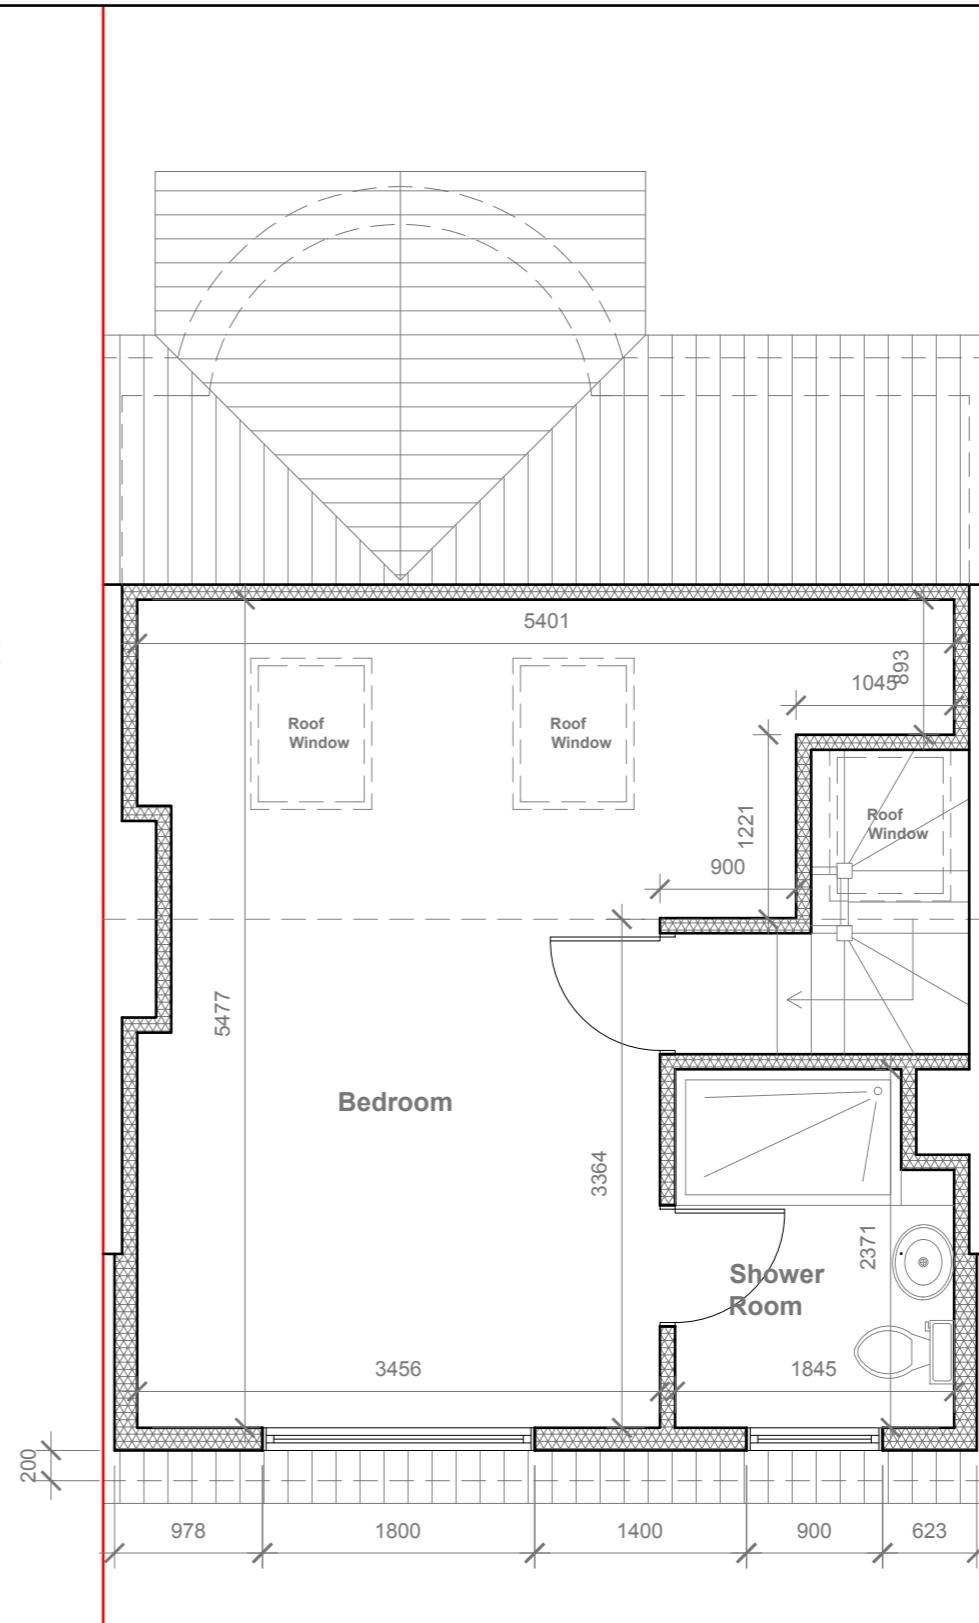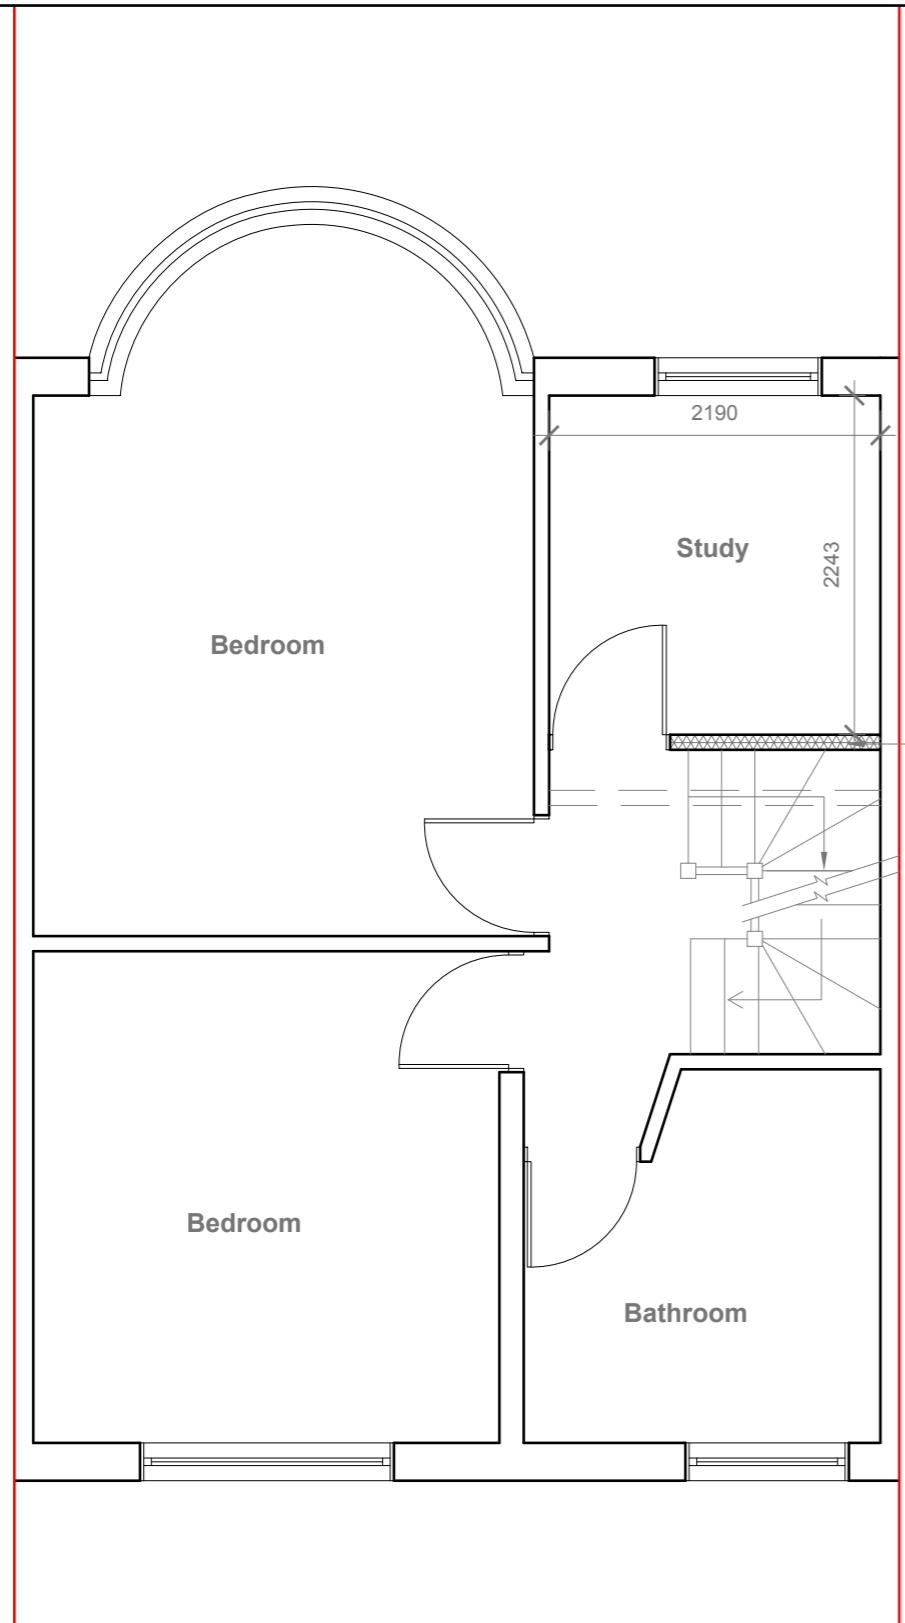

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Title:

Proposed First Floor & Loft Plans

Site Address	Scale: 1:50 @A3	Revision Date:
80 Cornwall Road, Ruislip, Middlesex HA4 6AN	Date: 28/04/2021	
	Drawing No.: 2021/64 -02	
	Drawn By: DP	
	e:mail - faluckpatel@yahoo.com (M) +44 (0) 7871 466 254	



Proposed Front Elevation

Scale 1:100



REAR DORMER VOLUME =

W X H X L / 2
5.701 X 2.467 X 3.513 / 2

V1 =


49.40 / 2
24.70 CU.MT. > 40 CU.MT.

Proposed External Finish Materials to Match Existing External Finish Materials



Proposed Rear Elevation

Scale 1:100

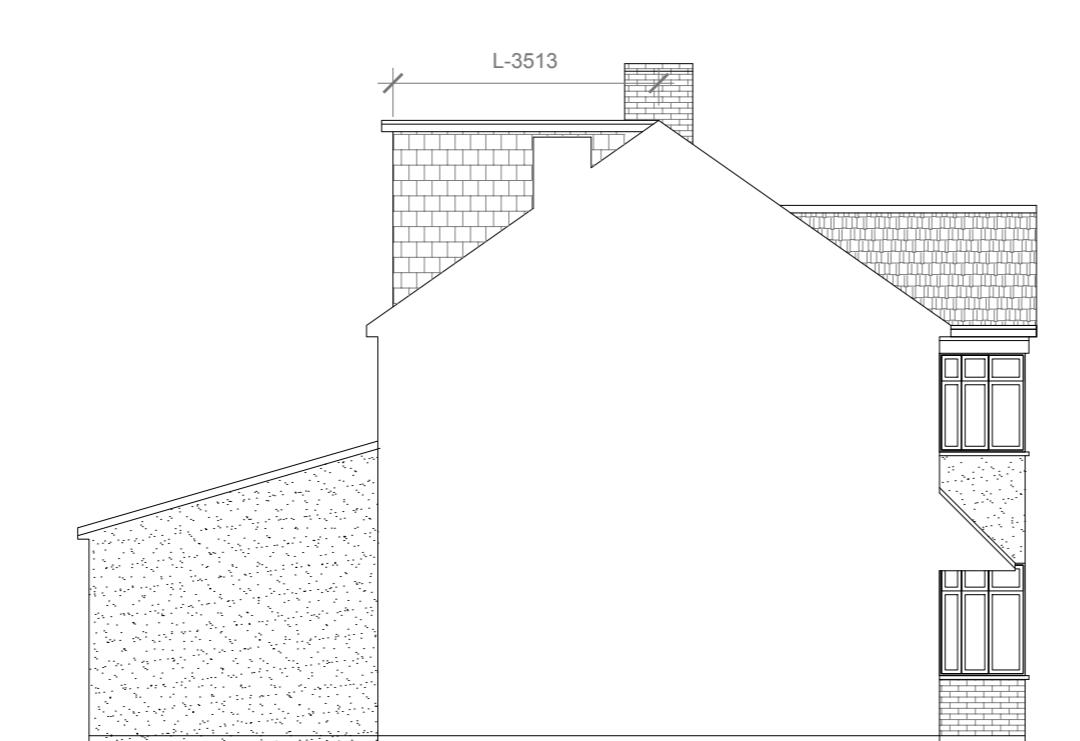

Proposed Side Elevation

Scale 1:100

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5
2
1
0

1:100

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Title:

Proposed Elevations

Site Address

80 Cornwall Road,
Ruislip,
Middlesex
HA4 6AN

Scale: 1:100 @A3
Date: 28/04/2021

Revision Date:

Drawing No.:
2021/64-03

Drawn By:
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