



Front Elevation

0 1 2 3 4 5
metres 1:100 scale

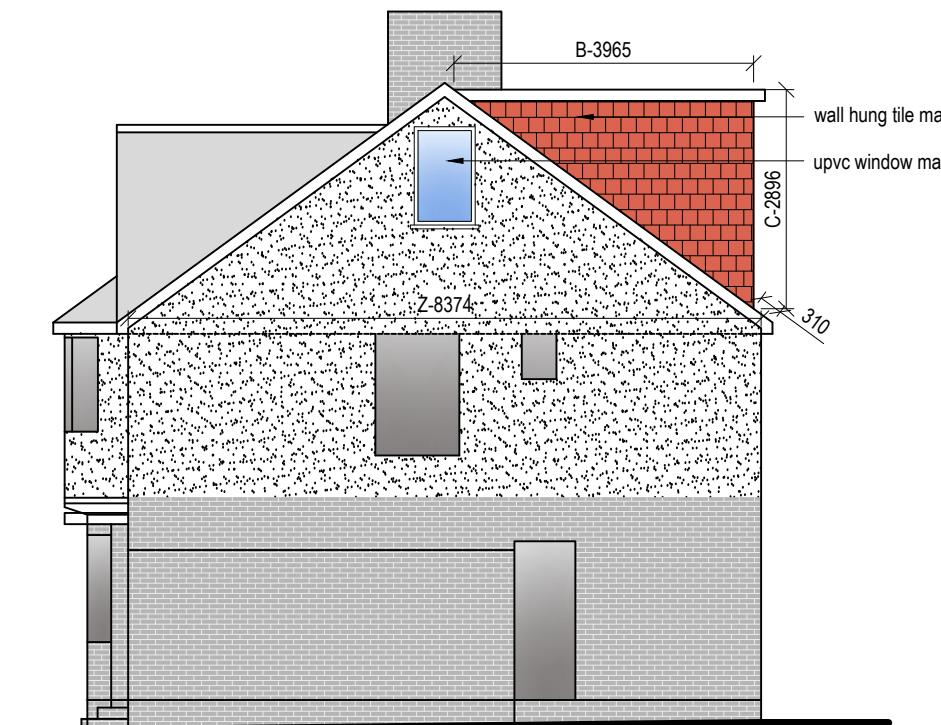

Side Elevation

0 1 2 3 4 5
metres 1:100 scale

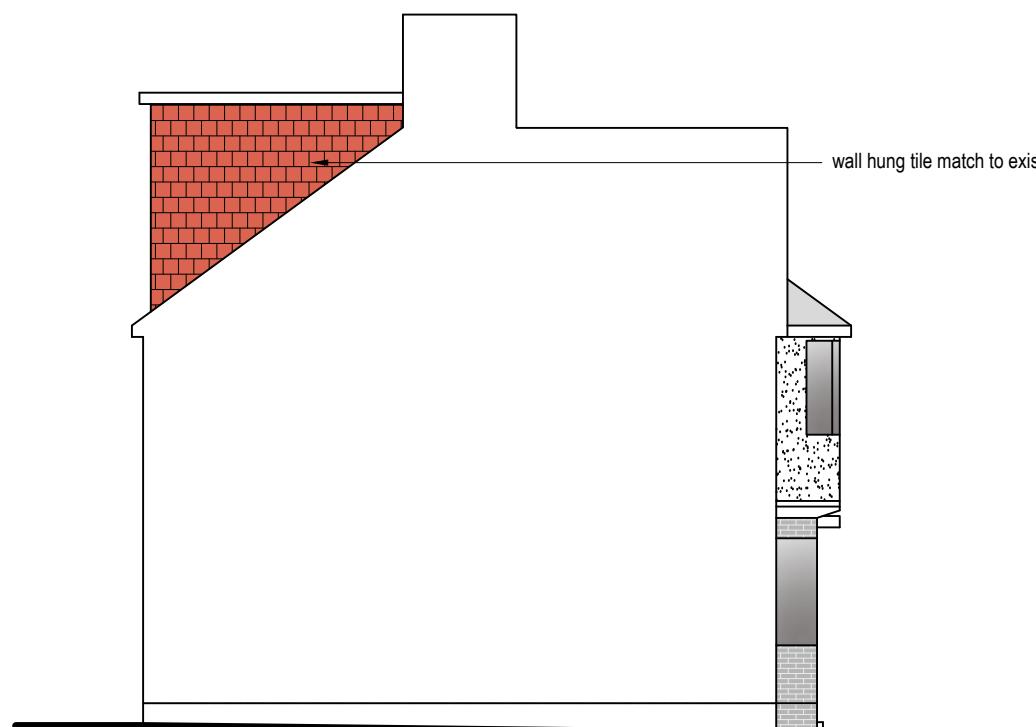

Side Elevation

0 1 2 3 4 5
metres 1:100 scale



Rear Elevation

0 1 2 3 4 5
metres 1:100 scale

VOLUME CALCULATION :-

1. HIP TO GABLE :-

$$X-4.207 \times Y-3.073 \times Z-8.374 \times \frac{1}{6} = 18.04 \text{ M3}$$

2. DORMER :-

$$A-5.516 \times B-3.965 \times C-2.896 \times \frac{1}{2} = 31.67 \text{ M3}$$

$$\text{TOTAL} :- 18.04 + 31.67 = 49.71 \text{ M3}$$

NOTE:

ANY WINDOW INSERTED ON WALL OR ROOF SLOPE FORMING A SIDE ELEVATION OF THE DWELLING SHALL BE:

1. OBSECURE P GLAZED
2. NON- OPENING UNLESS THE PARTS OF THE WINDOW WHICH CAN BE OPENED ARE MORE THAN 1.7 METERS ABOVE THE FLOOR OF THE ROOM IN WHICH THE WINDOW IS INSTALLED.
3. ROOF WINDOW WILL NOT PROTRUDE MORE THAN 150MM

Rev Date Comments



Dimensions to be verified on site.
DO NOT SCALE FROM THIS DRAWING.
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No responsibility is taken for their accuracy.


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Site Address:
60 Briarwood Drive,
Northwood,
HA6 1PW

Title:
Proposed Elevations


Drawn By: VP
Job Ref: 23066
Date: May 2023
Drawing No. LW - 04

Scale: 1:100 Paper Size: A3

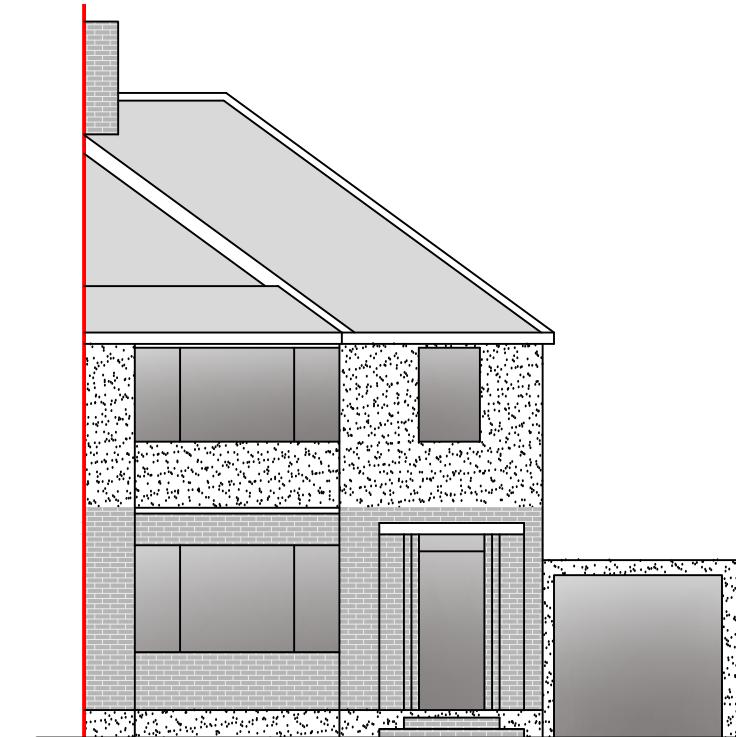


Front Elevation

0 1 2 3 4 5
metres 1:100 scale

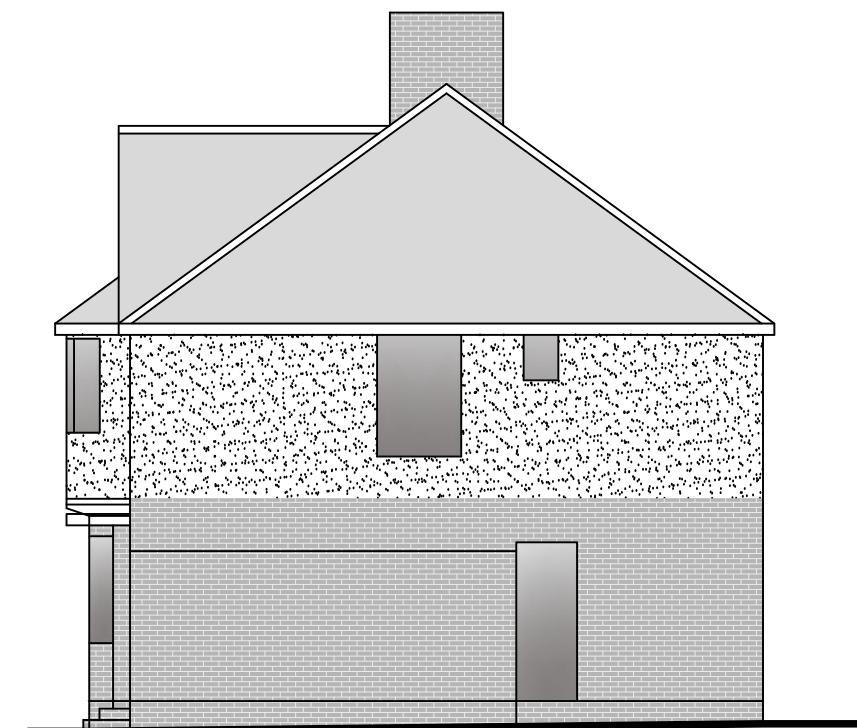


Side Elevation

0 1 2 3 4 5
metres 1:100 scale

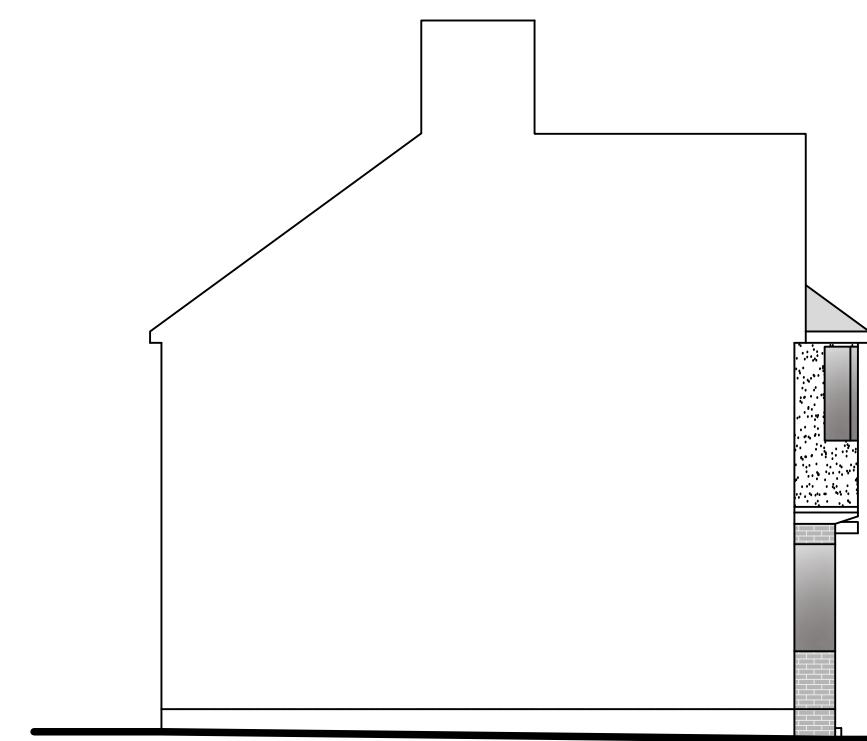

Side Elevation

0 1 2 3 4 5
metres 1:100 scale

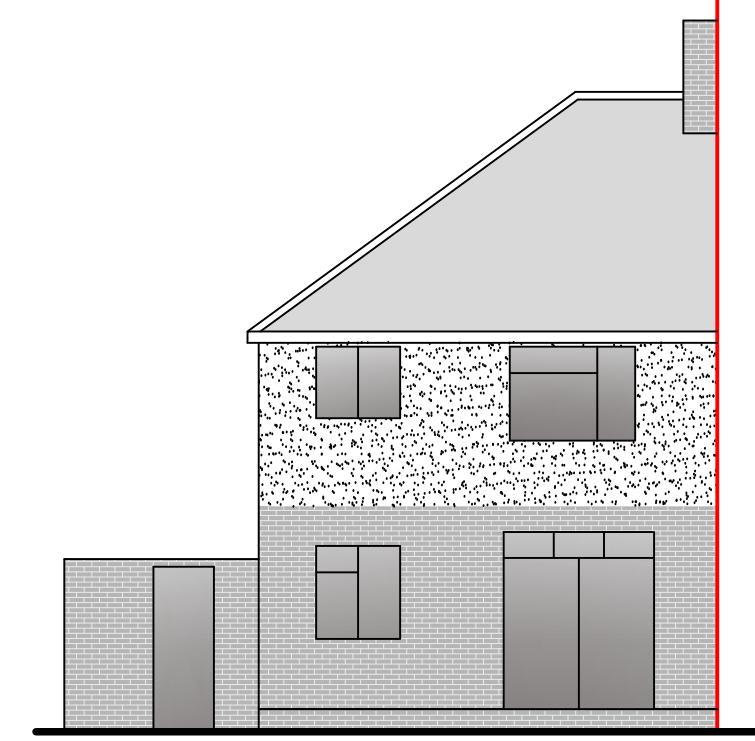

Rear Elevation

0 1 2 3 4 5
metres 1:100 scale

Rev Date Comments



Dimensions to be verified on site.
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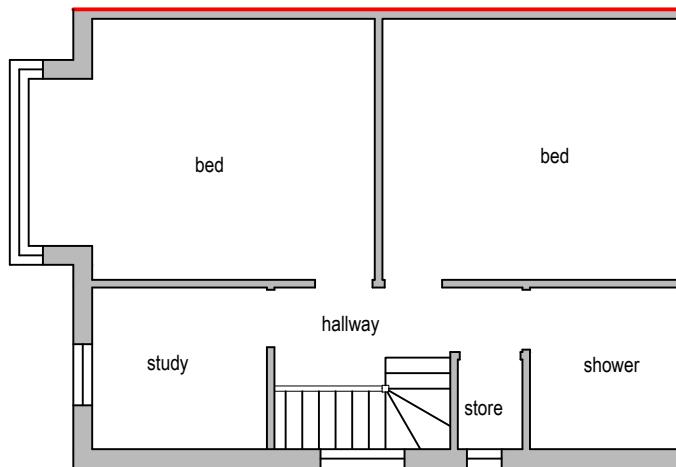
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Title:
Existing Elevations


Drawn By:	VP
Job Ref:	23066
Date:	May 2023
Drawing No.	LW - 03

Scale: 1:100 Paper Size: A3




Existing First Floor Plan

0 1 2 3 4 5
metres 1:100 scale

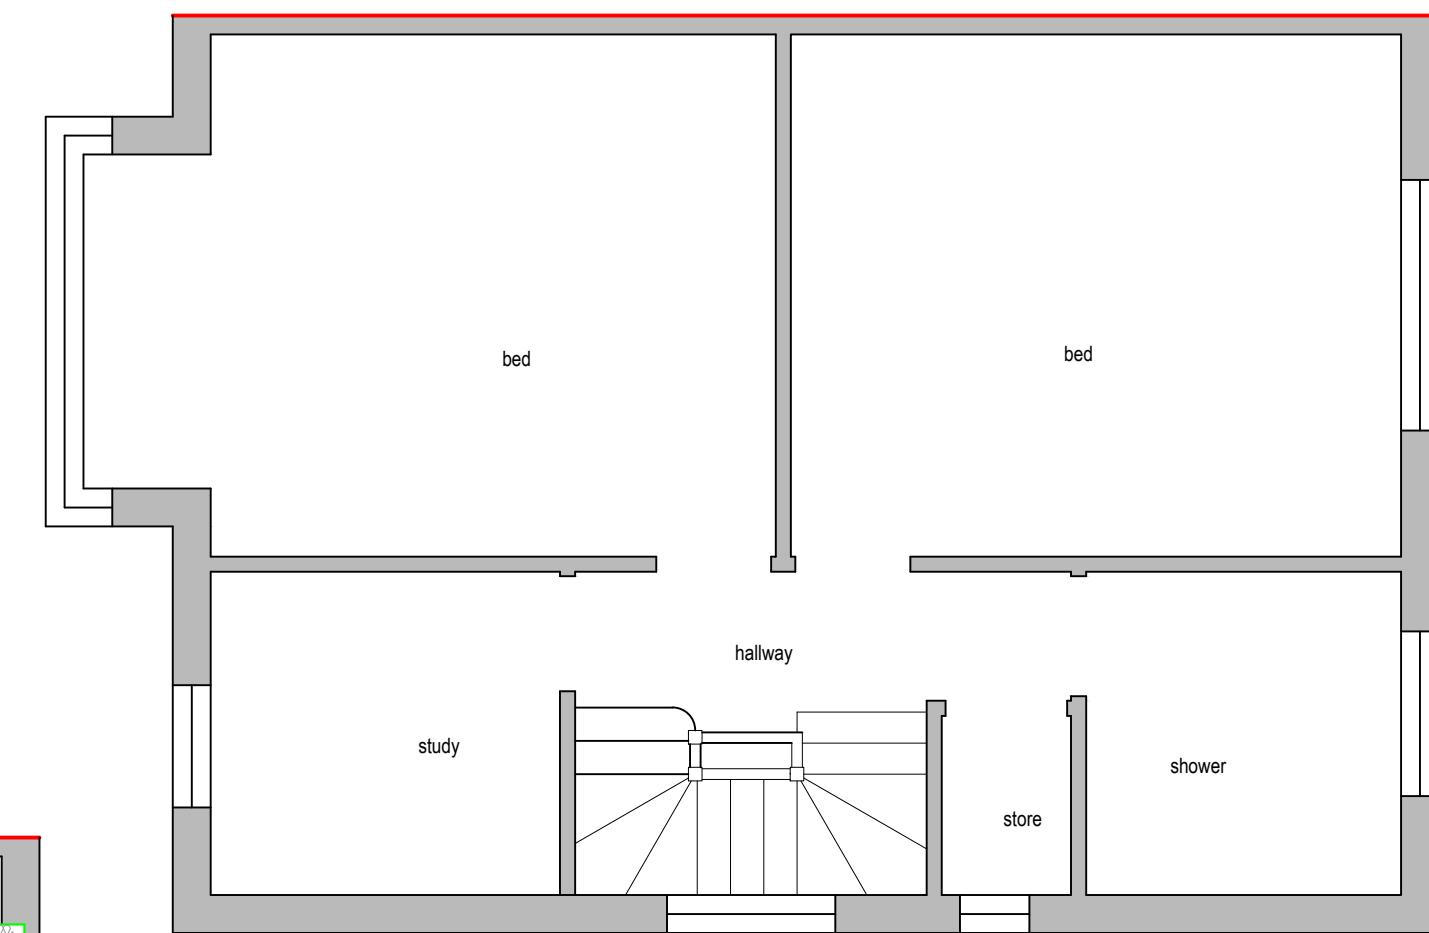

Proposed First Floor Plan

0 0.5 1.0 1.5 2.0 2.5
metres 1:50 scale

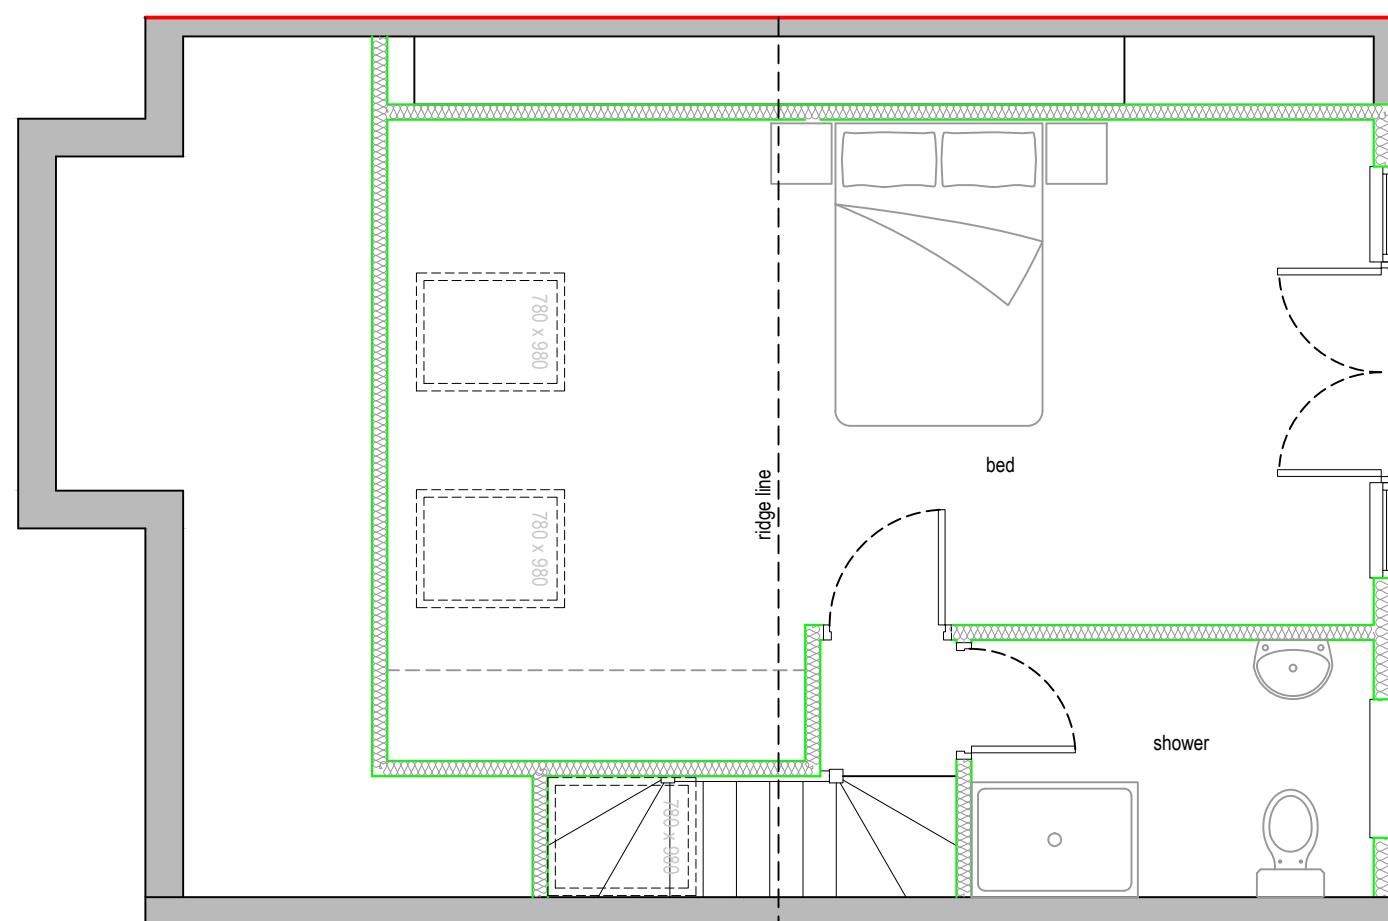

Proposed Loft Plan

0 0.5 1.0 1.5 2.0 2.5
metres 1:50 scale



Dimensions to be verified on site.
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Site Address:
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Northwood,
HA6 1PW

Title:
Existing & Proposed First Floor Plan and
Proposed Loft Plan

Scale: 1:50, 1:100 Paper Size: A3

Drawn By: VP
Job Ref: 23066
Date: May 2023
Drawing No. LW - 02



Rev Date Comments



Dimensions to be verified on site.
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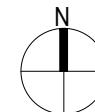
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Site Address:

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Northwood,
HA6 1PW

Title:

Block and Location Plans



Drawn By: VP
Job Ref: 23066
Date: May 2023
Drawing No. LW - 01

Scale: 1:500, 1:1250 Paper Size: A3