

LOFT DORMER VOLUME CALCULATION (LxWxH/2)


Existing dormer: X = 5.72, Y = 2.72, Z = 3.38

(5.72x2.72x3.38) ÷ 2 = **26.29 cubic metres**

Proposed dormer: A = 1.92, B = 1.54, C = 2.20

(1.92x1.54x2.20) ÷ 2 = **3.25 cubic metres**

**Total volume = 2.95+26.29 = 29.54 cubic metres**

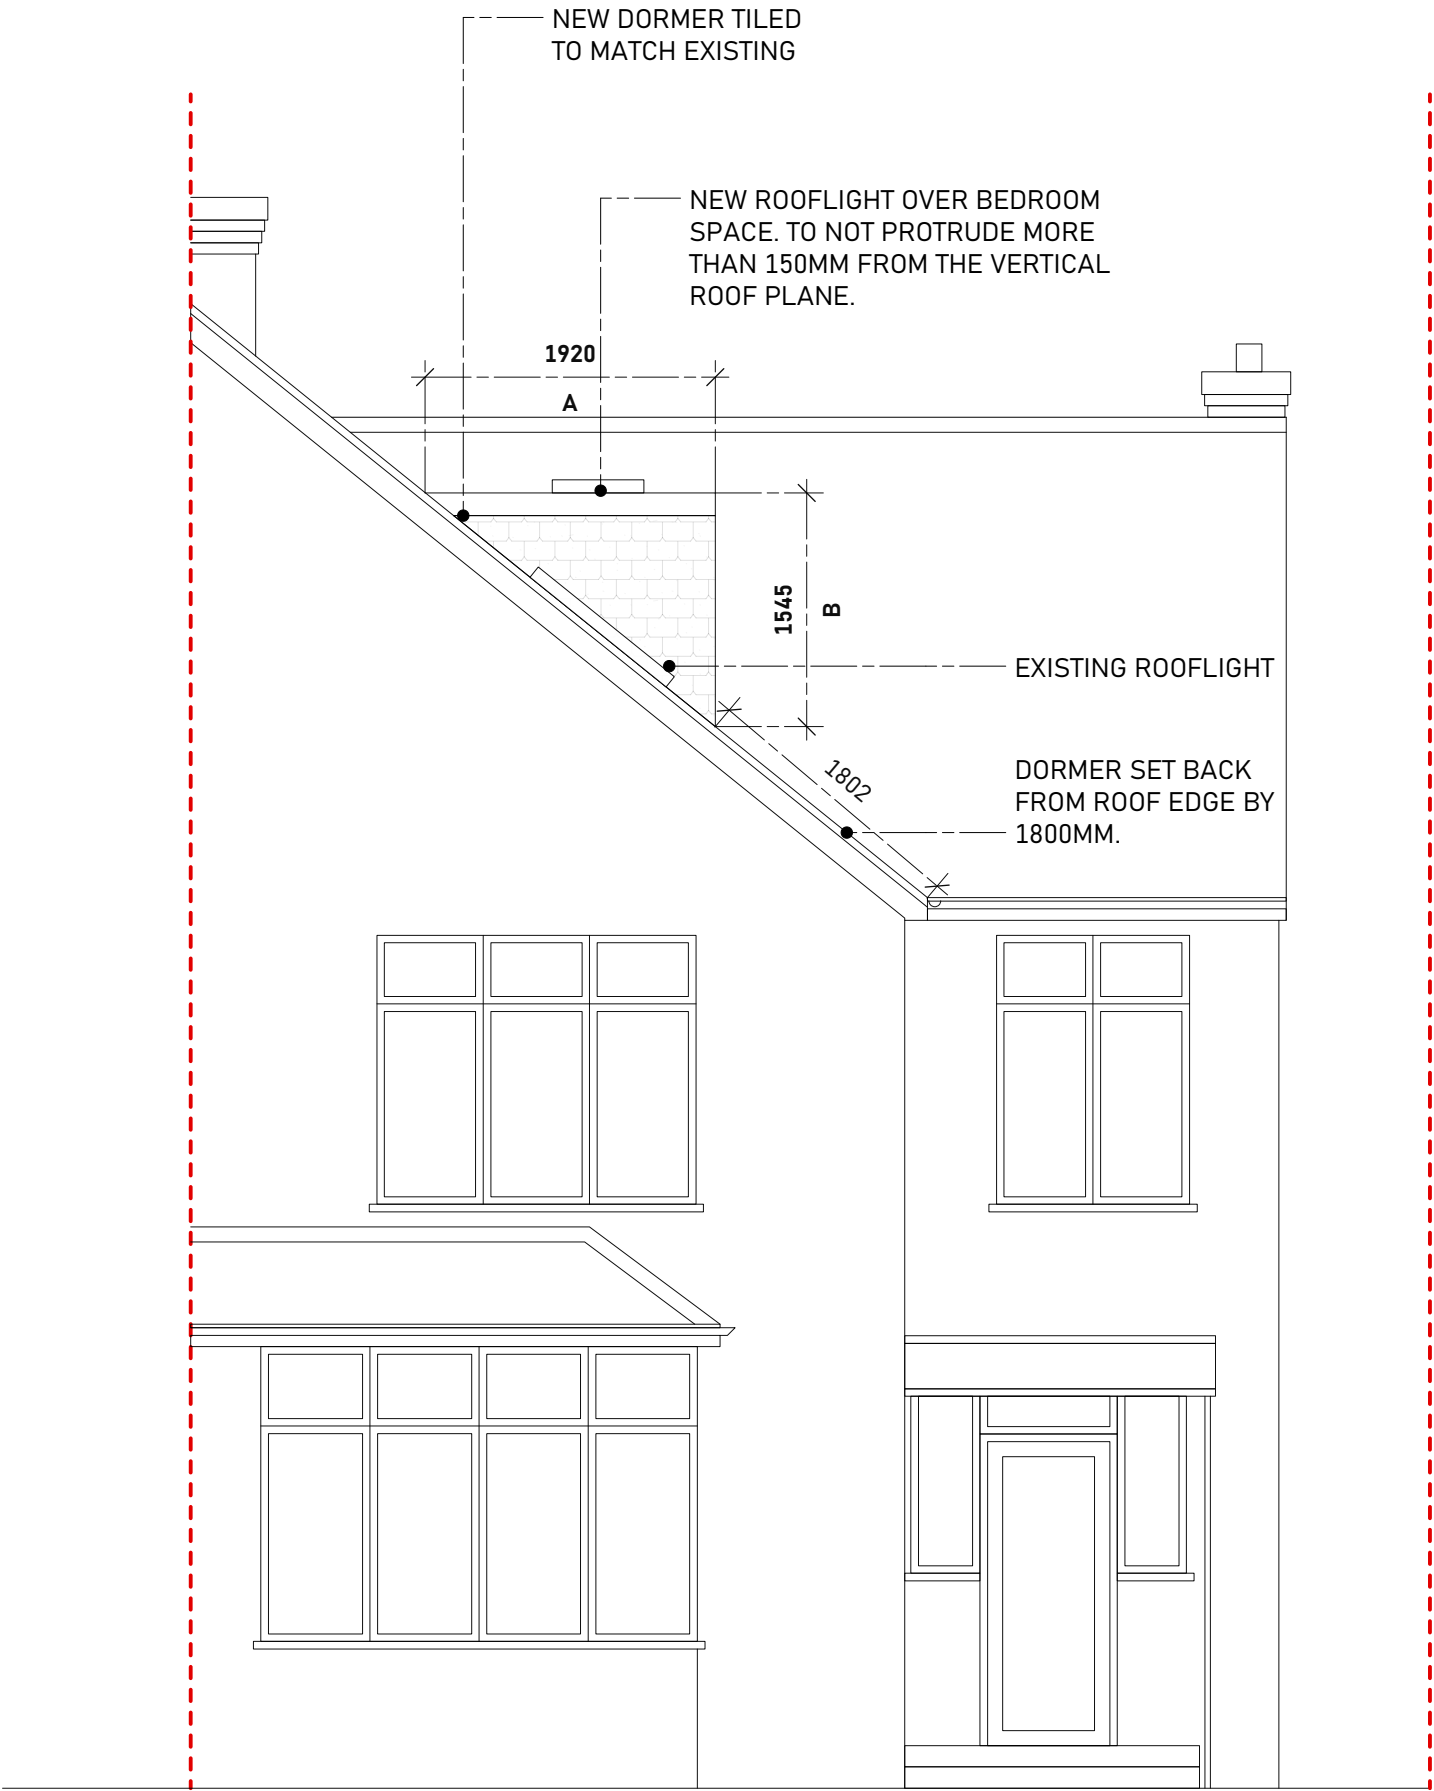

1 Proposed Front Elevation  
Scale: 1:50



2 Proposed Rear Elevation  
Scale: 1:50

(NO CHANGES TO REAR ELEVATION)



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27/03/23	D1	Initial Issue D
Date	No.	Revision Notes

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**Sheet Title**  
Proposed - Front and Rear Elevation

<b>Sheet Scale</b> 1:50	<b>Drawn By</b> JDT
<b>Sheet Date</b> 09/11/2022	<b>Reviewed By</b> JDT

**Sheet No.**  
0039-S3-P200  
**Stage**  
Planning

**Suitability**  
Code - Description  
A2 APPROVED FOR PLANNING  
STAGE