

LOFT DORMER VOLUME CALCULATION (LxWxH/2)


Existing dormer: X = 5.72, Y = 2.72, Z = 3.38

$(5.72 \times 2.72 \times 3.38) \div 2 = 26.29$ cubic metres

Proposed dormer: A = 3.38, B = 2.72, C = 5.00

$(3.38 \times 2.72 \times 5.00) \div 2 = 22.98$ cubic metres

Total volume = 22.98+26.29 = 49.274 cubic metres

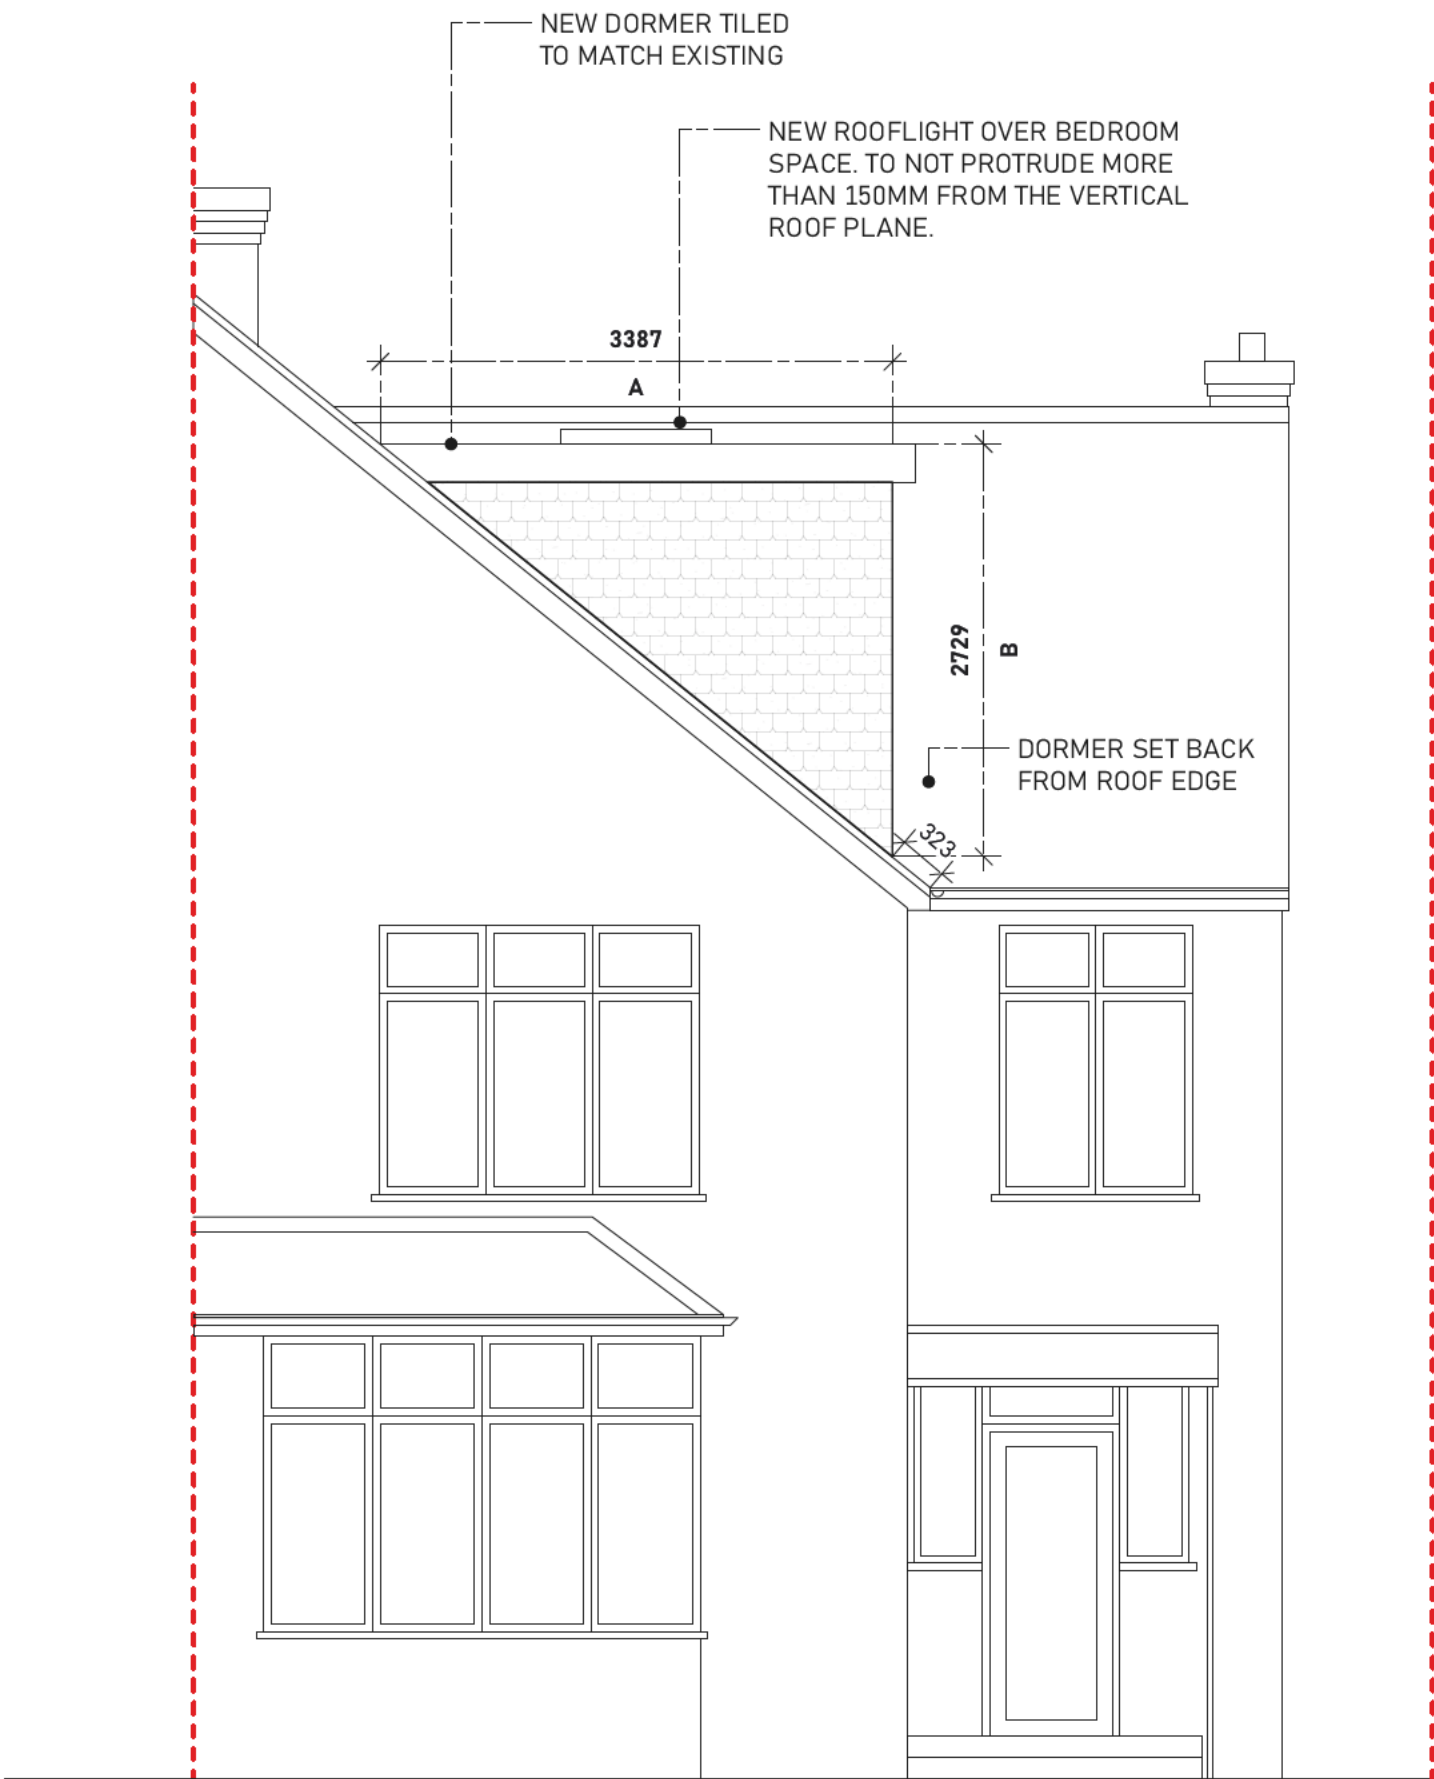

1 Proposed Front Elevation
Scale: 1:50



2 Proposed Rear Elevation
Scale: 1:50

(NO CHANGES TO REAR ELEVATION)



DISCLAIMER
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20/01/23	C1	Initial Issue C
24/11/22	B1	Initial Issue B
09/11/22	A1	Initial Issue A

Date	No.	Revision Notes
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20/01/23	C	Initial Issue
24/11/22	B	Initial Issue
09/11/22	A	Initial Issue

Date	No.	Issue Notes
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Sheet Title
Proposed - Front and Rear Elevation

Sheet Scale 1:50	Drawn By JDT
Sheet Date 09/11/2022	Reviewed By JDT

Sheet No.
0039-S3-P200
Stage
Planning

Suitability
A2 APPROVED FOR PLANNING
STAGE