




Existing Front Elevation 1:100

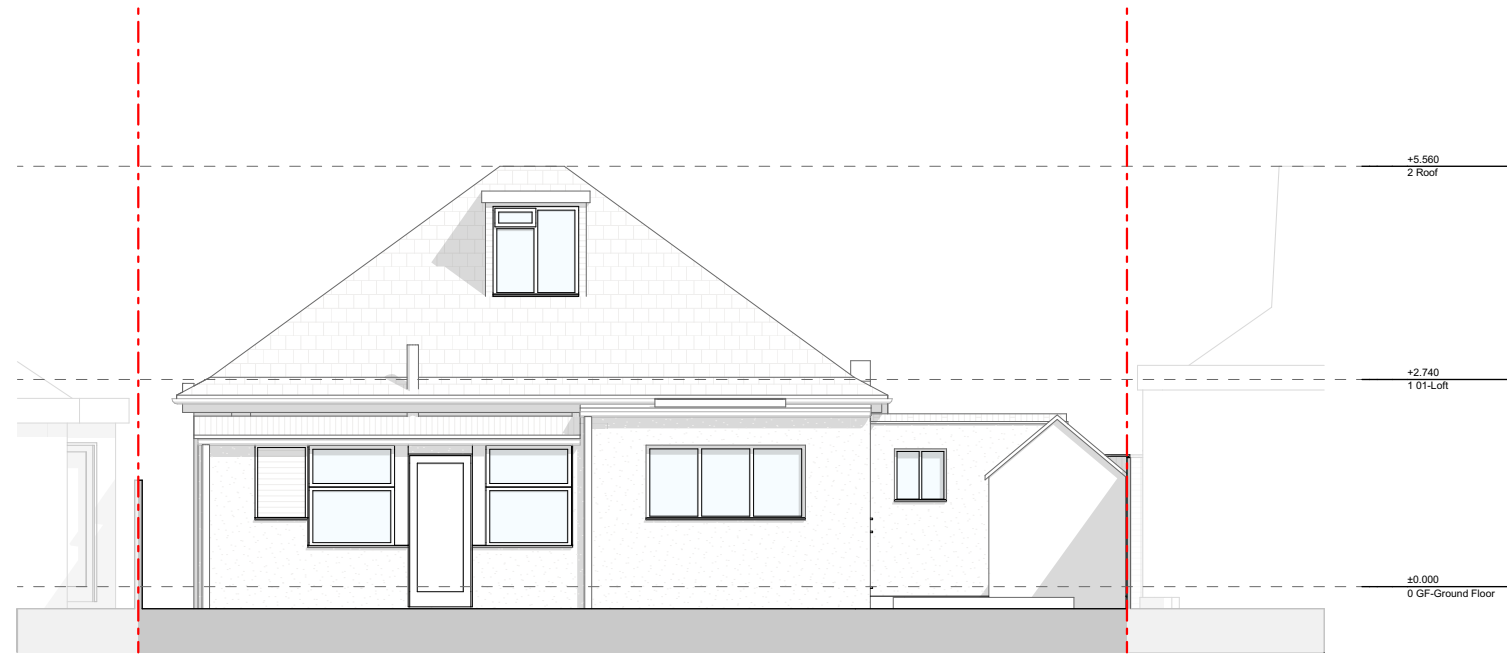


Existing Rear Elevation 1:100

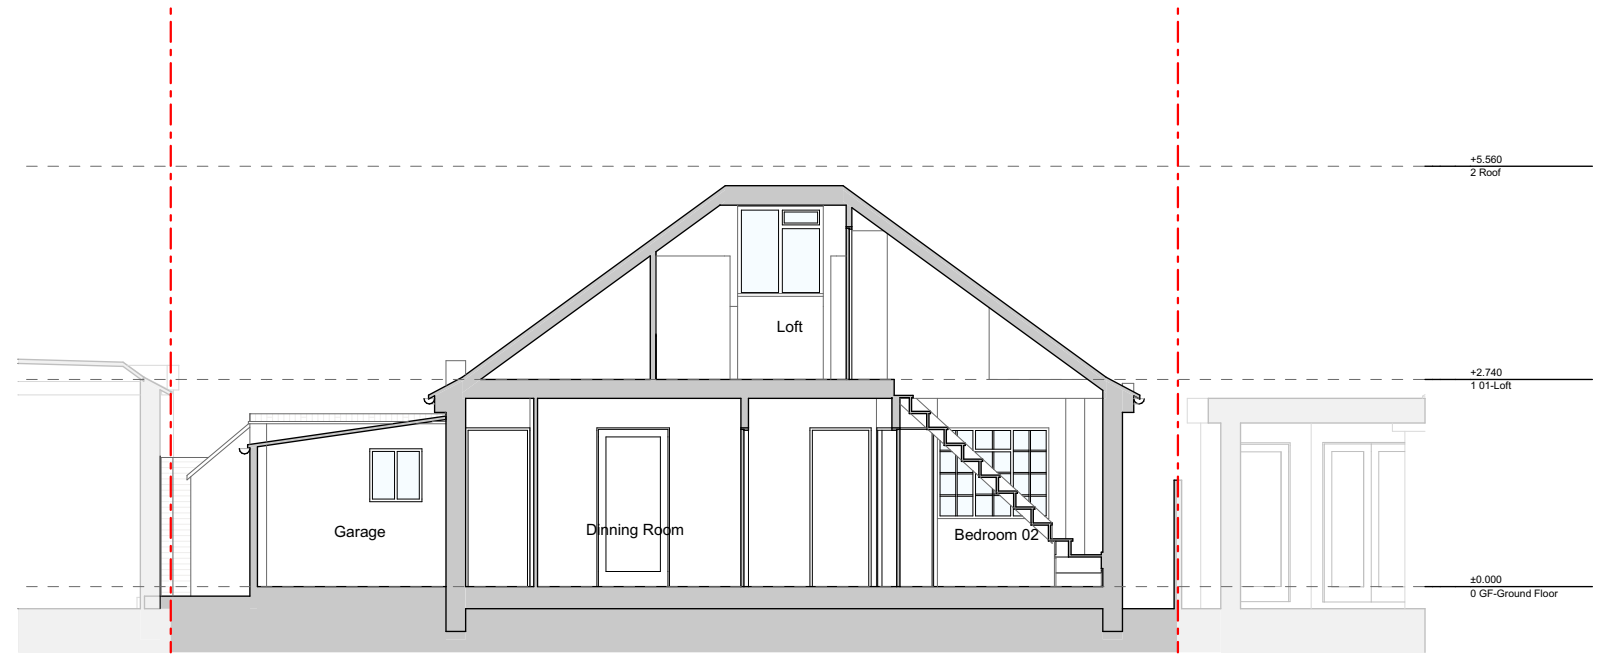


Existing Section A 1:100

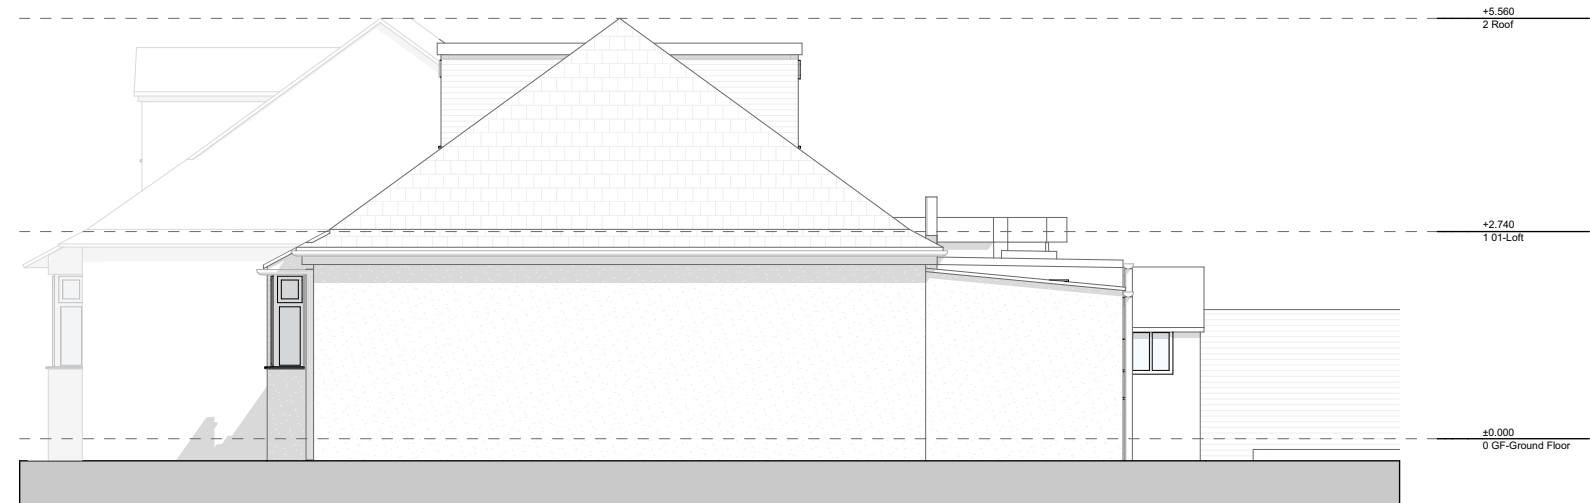


Existing Side Elevation 1:100

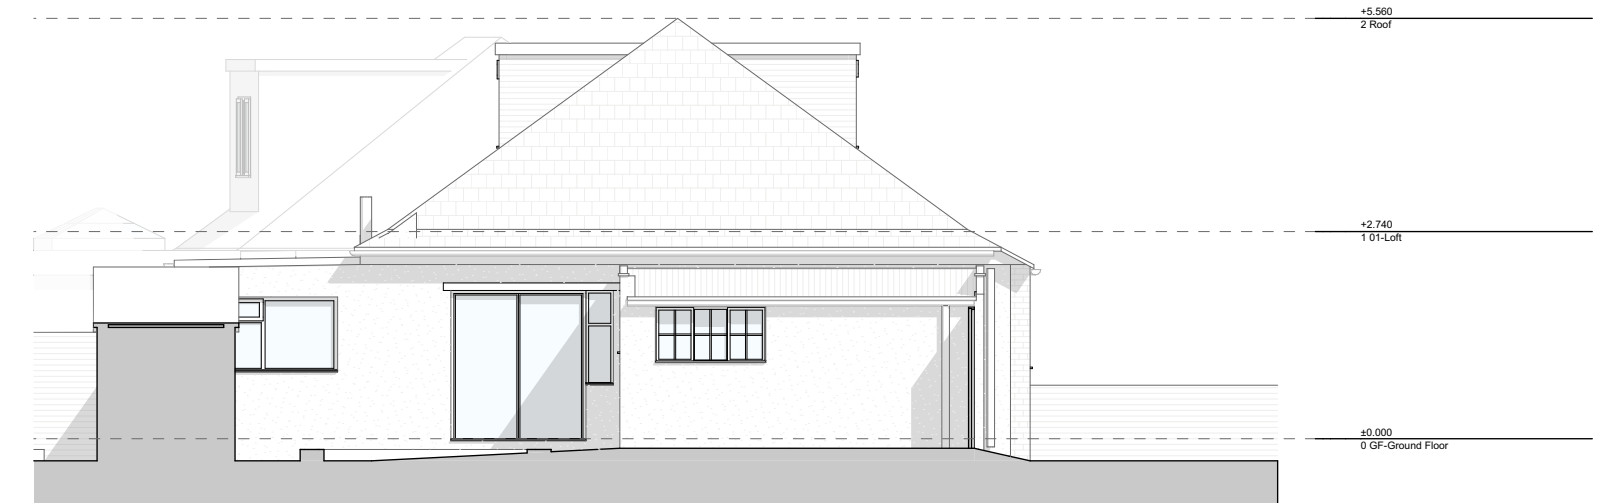

Existing Side Elevation 1:100

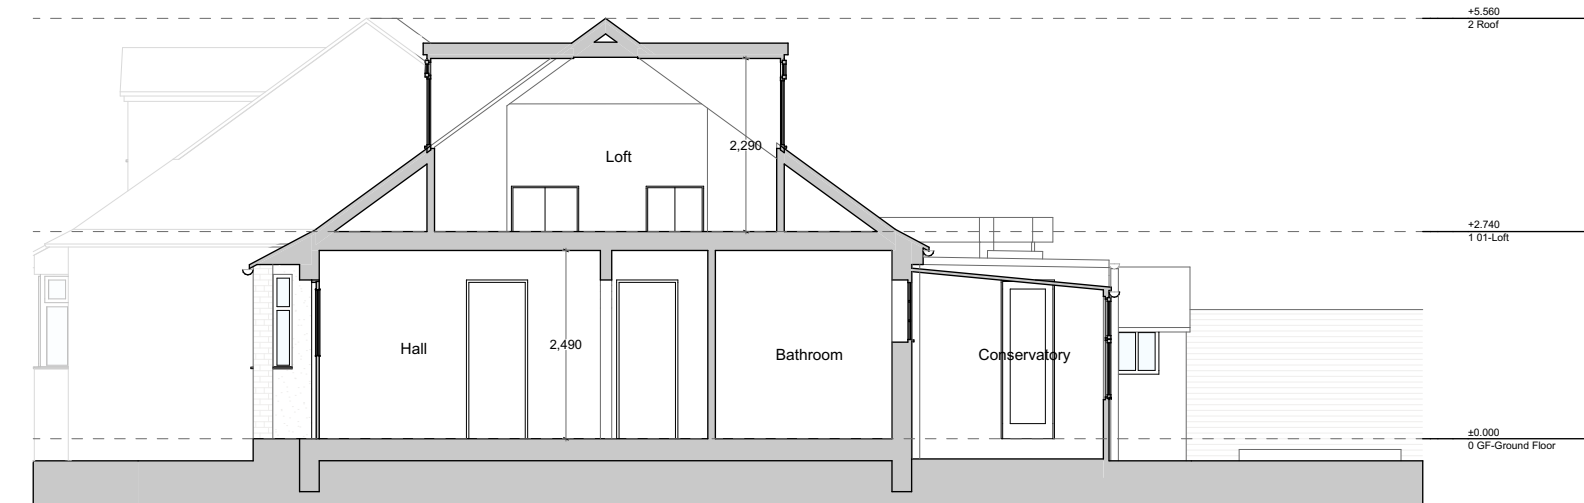


Existing Section B 1:100

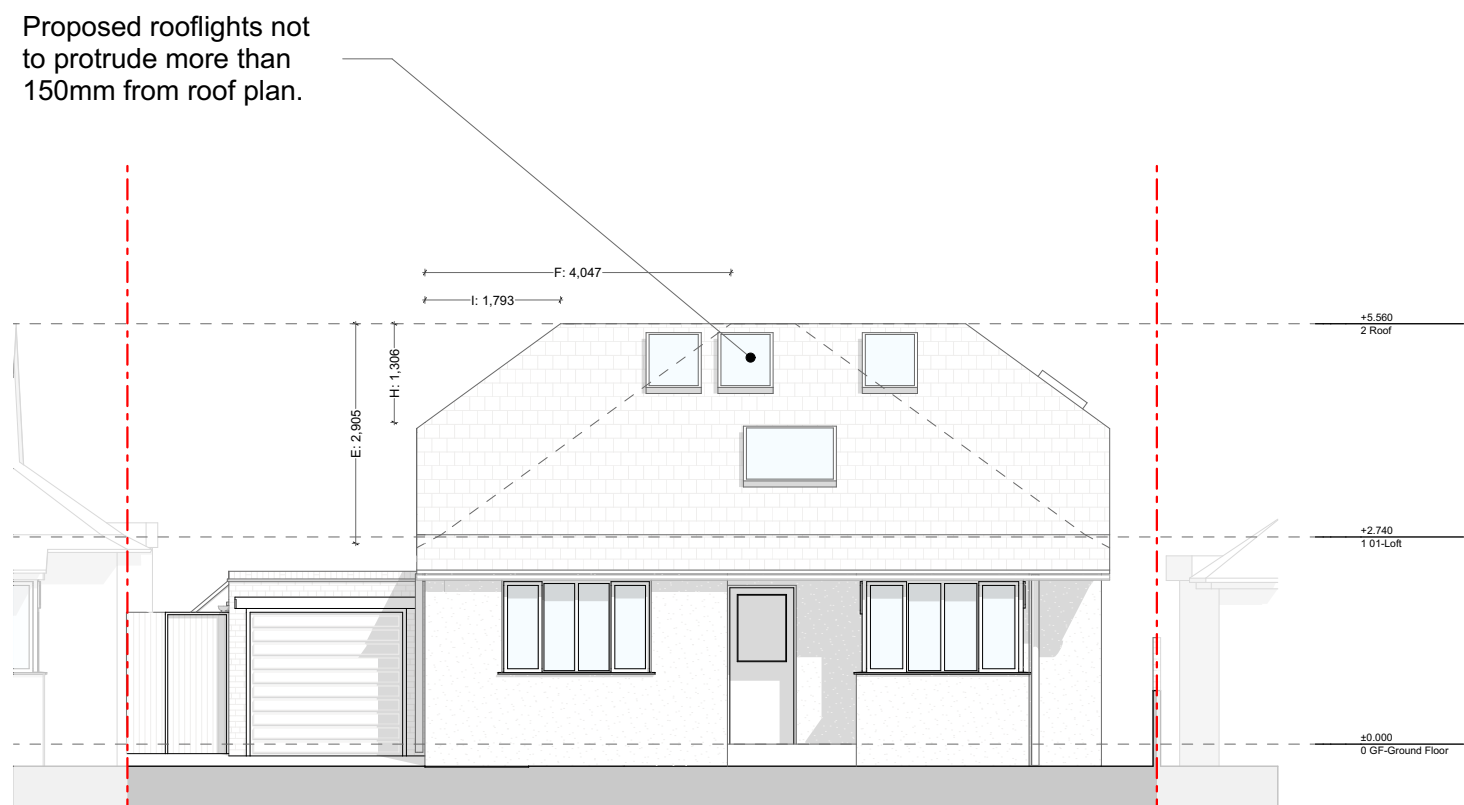


Proposed Front Elevation 1:100




Proposed Rear Elevation 1:100

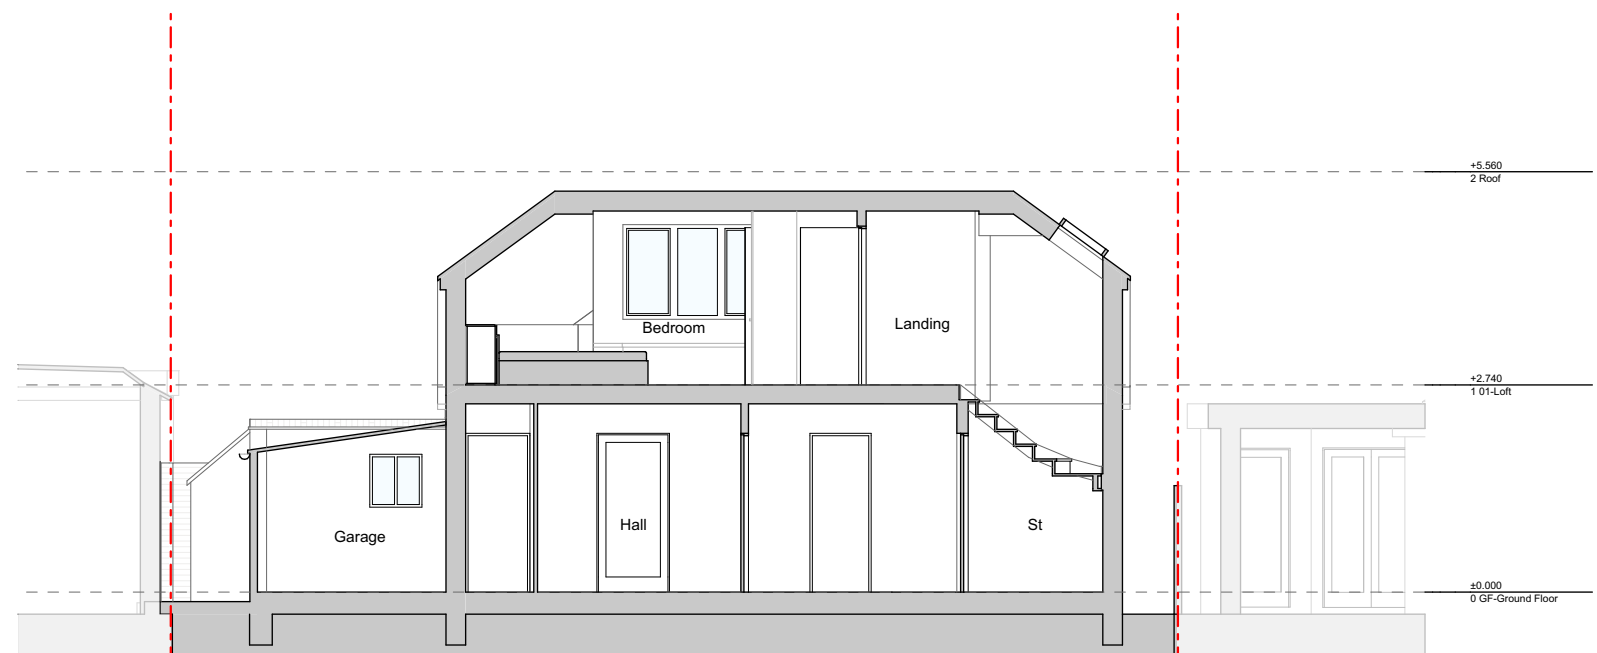


Proposed Section A 1:100

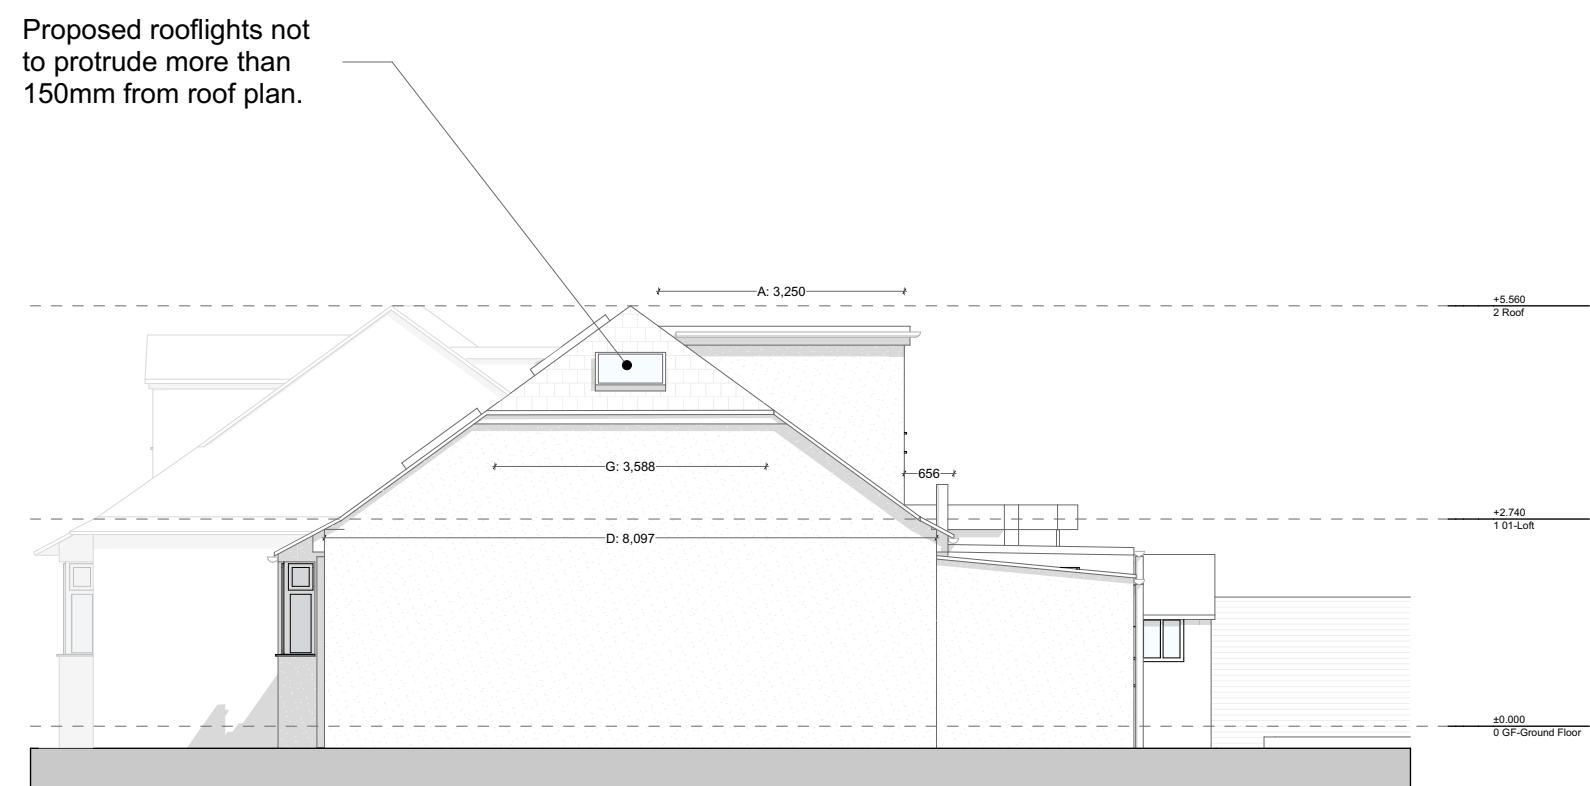

Proposed Side Elevation 1:100

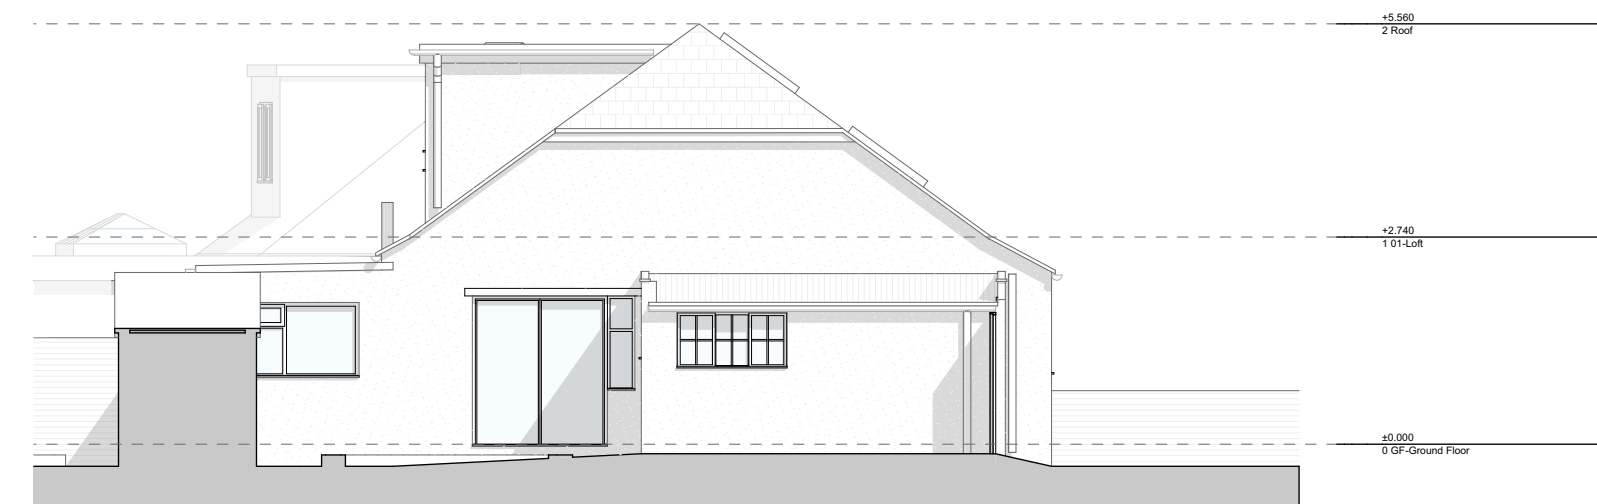

Proposed Side Elevation 1:100

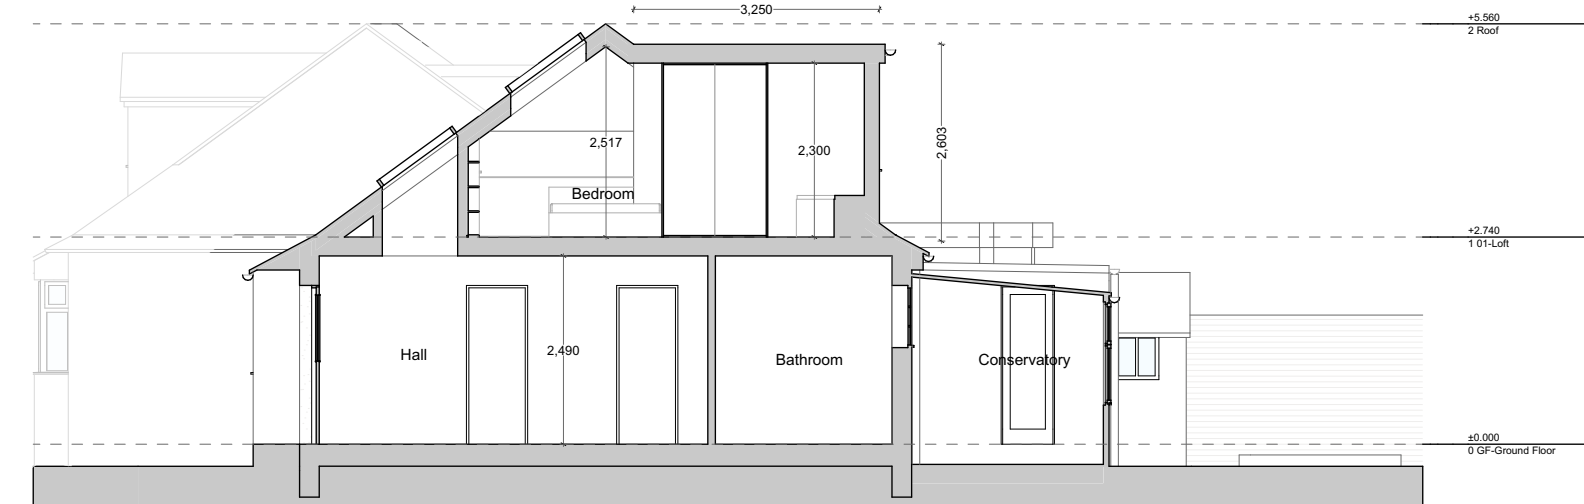

Proposed Section B 1:100

Notes

All materials to match existing.

TOTAL VOLUME FORMULA:
Total volume allowed: 50m3

Dormer: $Y = 1/2 (A \times B \times C)$

Roof: $X = 1/3 (((D \times E) / 2) \times F) - 1/3 (((G \times H) / 2) \times I)$

$Y = 1/2 (3.250 \times 2.367 \times 5.450 \text{m}) <=>$

Y = 20.963 m3


$X = 1/3 (((8.097 \text{m} \times 2.905 \text{m}) / 2) \times 4.047 \text{m}) - 1/3 (((3.588 \text{m} \times 1.306 \text{m}) / 2) \times 1.793 \text{m}) <=>$
 $X = 15.865 \text{m}^3 - 1.400 \text{m}^3 <=>$
X = 14.465m3

Total Volume = Y + 2X

Total Volume = 49.893 m3

A = 3.250m F = 4.047m
B = 2.367m G = 3.588m
C = 5.450m H = 1.306m
D = 8.097m I = 1.793m
E = 2.905m

Scale 1:100

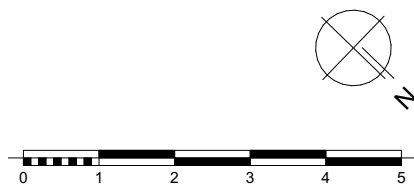

Rev	Issue Name	Date
A	Planning Issue	18/08/2020

Scale	A1 - 1:100
Drawn by	CC
Revision	A
Issue Date	18/08/2020

Drawing Nr.	66.02-P-4
Drawing Name	Existing and Proposed Sections and Elevations

Project ID	66
Client	Jeff Lloyd
Site	37 The Greenway, UB10 8LS

Planning

DASH

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