


Existing Ground Floor Plan

Scale 1:100

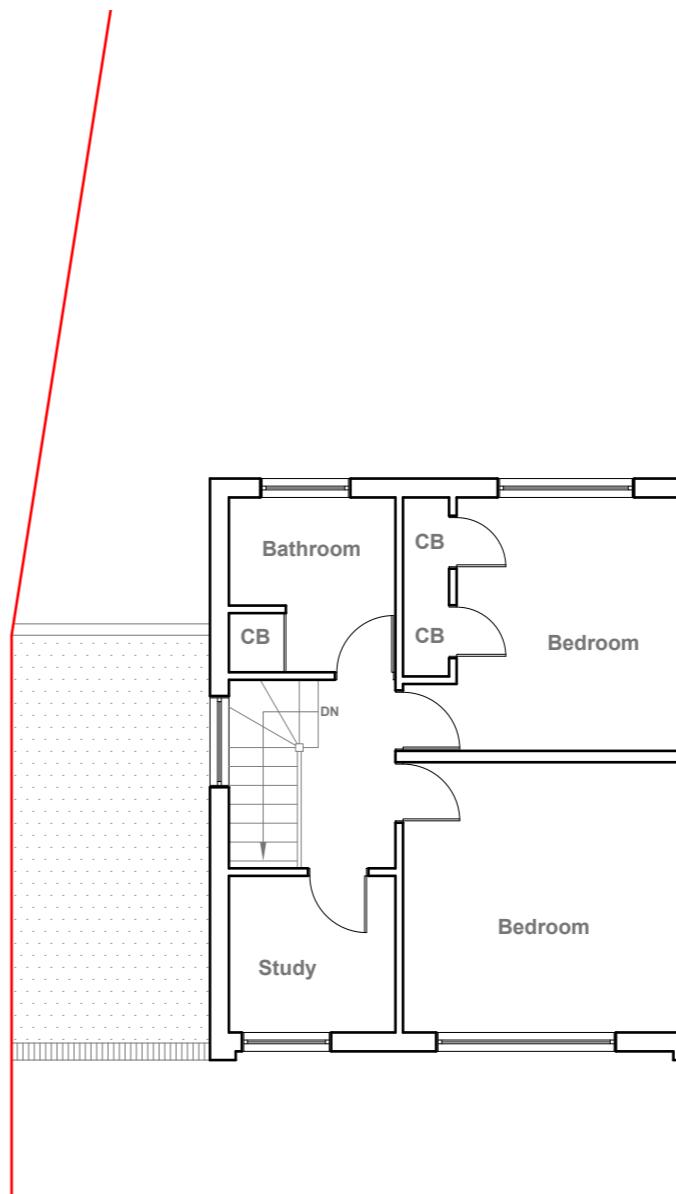

Existing First Floor Plan

Scale 1:100

10 Meter
5
2
1
0

Faluck Patel

GENERAL NOTES:
 1. ALL DIMENSIONS ARE IN MILLIMETER.
 2. VERIFY ALL DIMENSIONS AND CONDITIONS BEFORE BUILDING OR
 STARTING CONSTRUCTION. NOTIFY THE DESIGNER IMMEDIATELY OF ANY
 DISCREPANCY OR VARIATION.
 3. ALL WORK TO COMPLY WITH CURRENT BUILDING REGULATIONS
 AND CODES OF PRACTICE

Title:

Existing Floor Plans

Site Address
19A Kingsway,
Hayes.
UB3 2TT


Scale: 1:100 @A3
Date: 15/09/2025
Drawing No.:
2025/137 -01

Revision Date:
Drawn By:
RO
e:mail -
faluckpatel@yahoo.com
(M) +44 (0) 7871 466 254



Existing Front Elevation

Scale 1:100

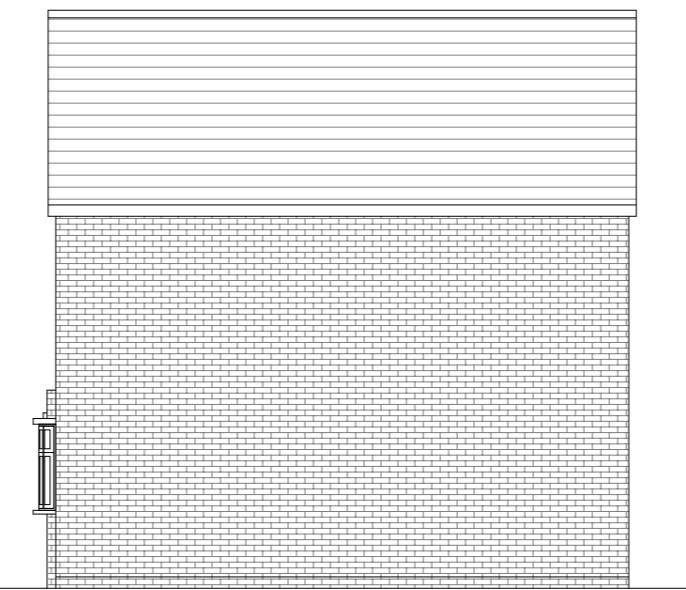


Existing Side Elevation

Scale 1:100



Existing Rear Elevation

Scale 1:100

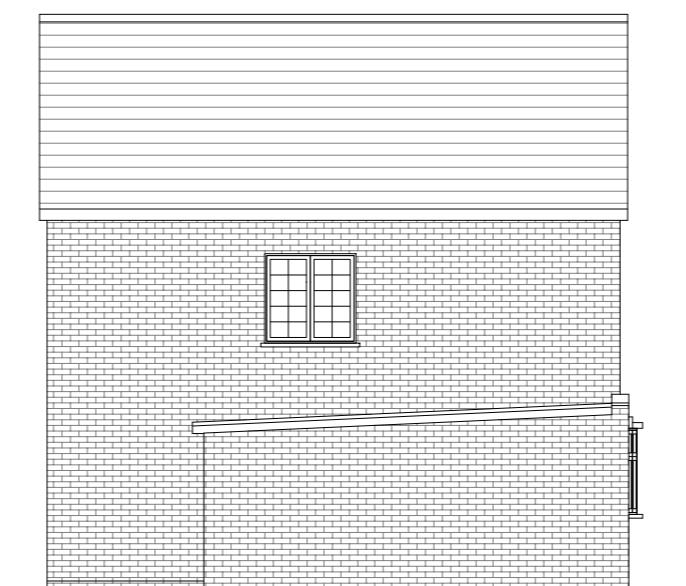

Existing Side Elevation

Scale 1:100

10 Meter
5
2
1
0
1:100

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AND CODES OF PRACTICE

Title:


Existing Elevations

Site Address
19A Kingsway,
Hayes.
UB3 2TT

Scale: 1:100 @A3
Date: 15/09/2025
Drawing No.:
2025/137 -02


Revision Date:
Drawn By:
RO
e:mail -
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Faluck Patel

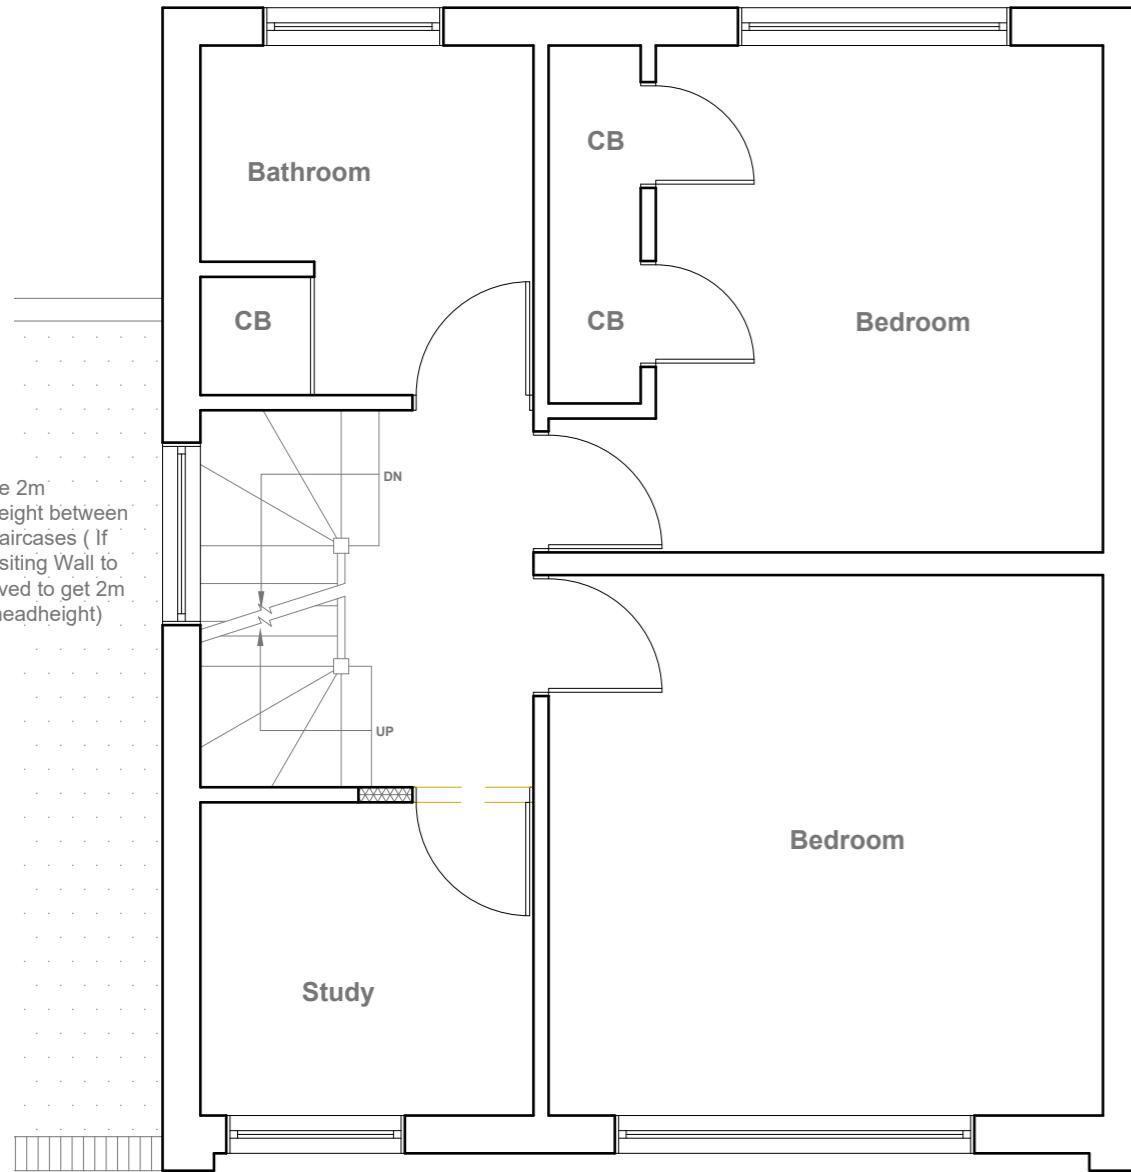

Proposed First Floor Plan

Scale 1:50

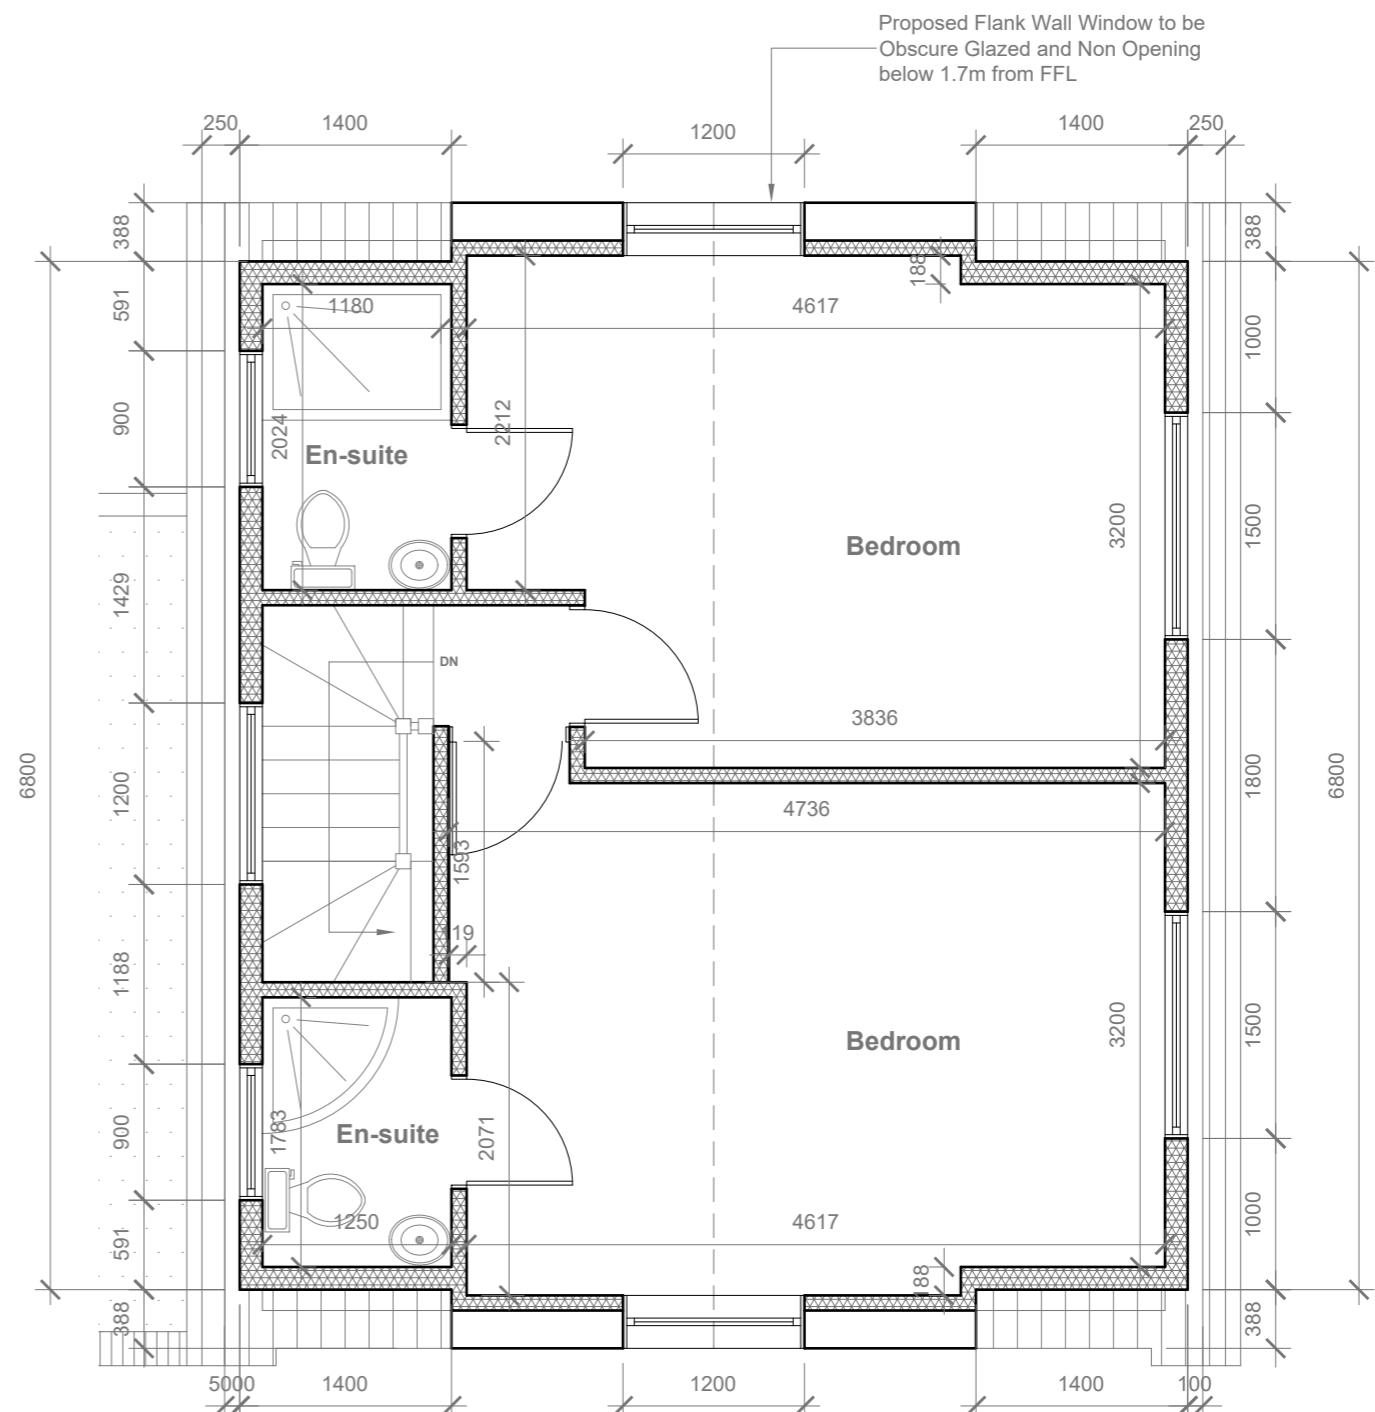

Proposed Loft Floor Plan

Scale 1:50

GENERAL NOTES:

1. ALL DIMENSIONS ARE IN MILLIMETER.
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3. ALL WORK TO COMPLY WITH CURRENT BUILDING REGULATIONS AND CODES OF PRACTICE

Title:

Proposed First Floor & Loft Plans

Site Address

19A Kingsway,
Hayes.
UB3 2TT

Scale: 1:50 @A3

Date: 15/09/2025
Drawing No.: 2025/137 -03

Revision Date:

Drawn By:
RO

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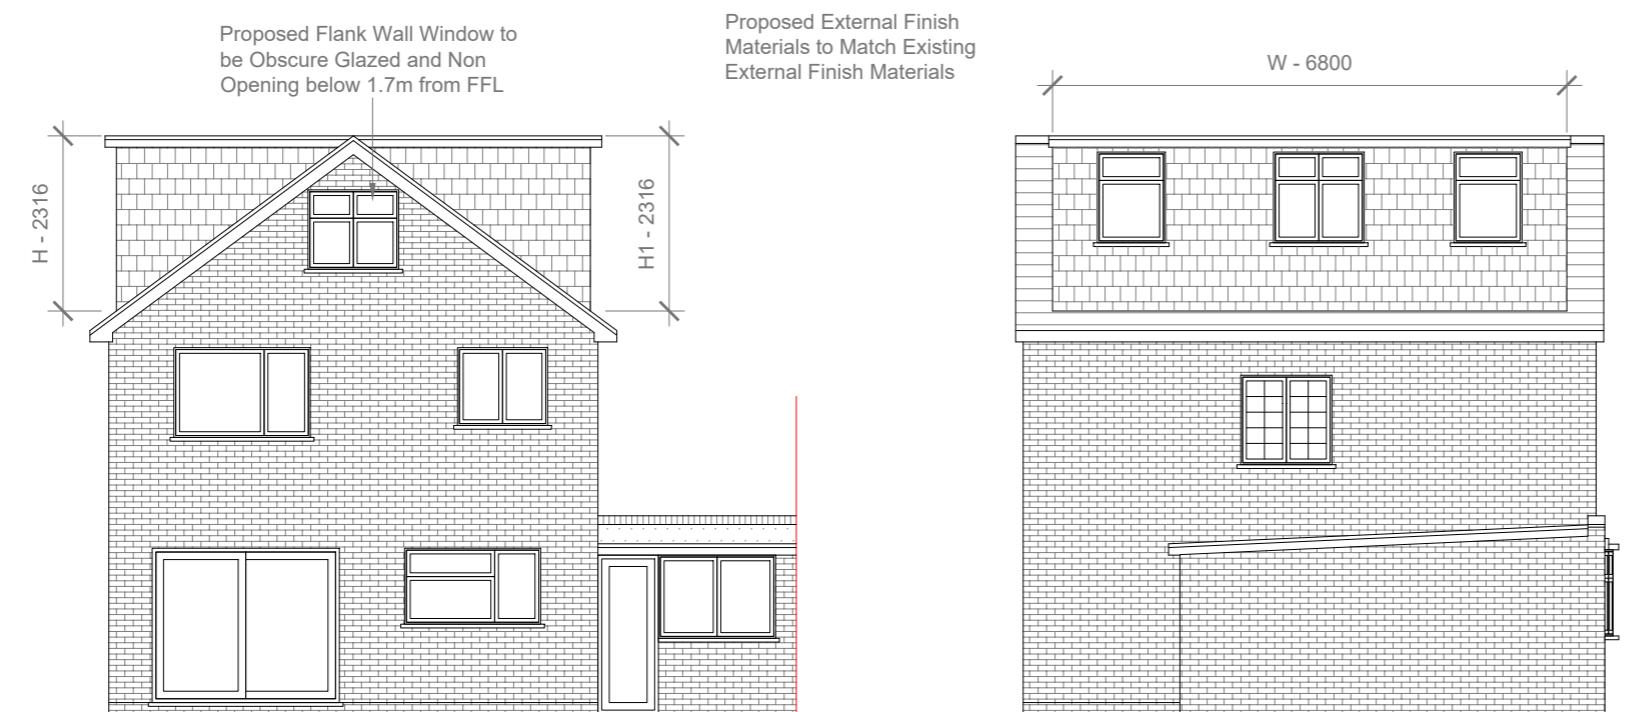


Proposed Front Elevation

Scale 1:100

Proposed Side Elevation

Scale 1:100



Proposed Rear Elevation

Scale 1:100

Proposed Side Elevation

Scale 1:100

$$\begin{aligned}
 \text{SIDE DORMER VOLUME} &= W \times H \times L / 2 \\
 &= 6.800 \times 2.316 \times 3.134 / 2 \\
 &= 49.35 / 2 \\
 &= 24.67 \text{ CU.MT.}
 \end{aligned}$$

$$\begin{aligned}
 \text{V1} &= \\
 \text{SIDE DORMER VOLUME} &= W \times H \times L / 2 \\
 &= 6.800 \times 2.316 \times 3.134 / 2 \\
 &= 49.35 / 2 \\
 &= 24.67 \text{ CU.MT.}
 \end{aligned}$$

$$\begin{aligned}
 \text{V2} &= \\
 \text{TOTAL ROOF VOLUME} &= V1 + V2 \\
 &= 24.67 + 24.67 \\
 &= 49.35 \text{ CU.MT.} < 50.00 \text{ CU.MT.}
 \end{aligned}$$

10 Meter
5
2
1
0
1:100

GENERAL NOTES:
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 AND CODES OF PRACTICE

Title:

Proposed Elevations

Site Address	Scale: 1:100 @A3	Revision Date:
19A Kingsway, Hayes. UB3 2TT	Date: 15/09/2025	
	Drawing No.: 2025/137 -04	
	Drawn By: RO	
	e:mail - faluckpatel@yahoo.com (M) +44 (0) 7871 466 254	