


Existing Ground Floor Plan
Scale 1:100

Existing Front Elevation
Scale 1:100

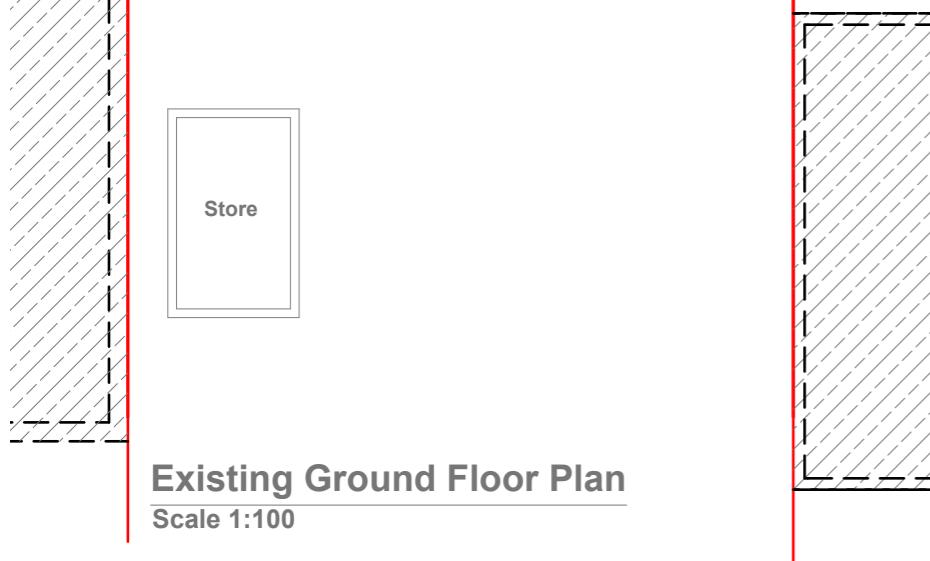

Existing Side Elevation
Scale 1:100




1:100 0 1 2 5 10 Meter

Existing Rear Elevation
Scale 1:100



Existing Side Elevation
Scale 1:100

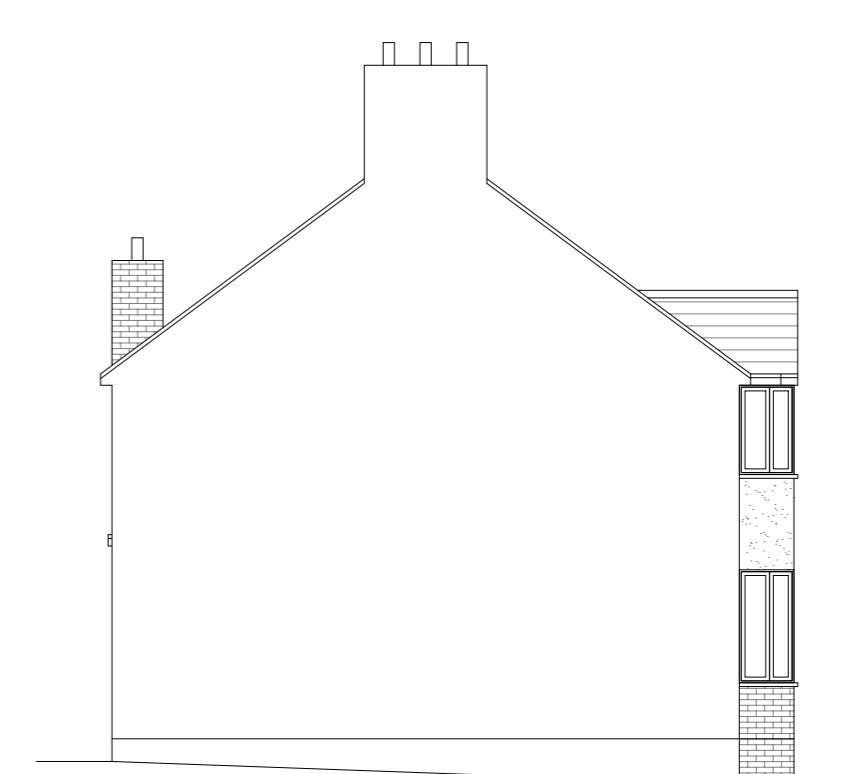

GENERAL NOTES:
 1. ALL DIMENSIONS ARE IN MILLIMETER.
 2. VERIFY ALL DIMENSIONS AND CONDITIONS BEFORE BUILDING OR
 STARTING CONSTRUCTION. NOTIFY THE DESIGNER IMMEDIATELY OF ANY
 DISCREPANCY OR VARIATION.
 3. ALL WORK TO COMPLY WITH CURRENT BUILDING REGULATIONS
 AND CODES OF PRACTICE

Title:


Existing Ground Floor Plan & Elevations

Site Address
11 Newnham Avenue
Eastcote.
HA4 9RW

Scale: 1:100 @A3
Date: 26/11/2024
Drawing No.: 2024/190 -01
Drawn By:
RO

Revision Date:

e:mail -
faluckpatel@yahoo.com
(M) +44 (0) 7871 466 254

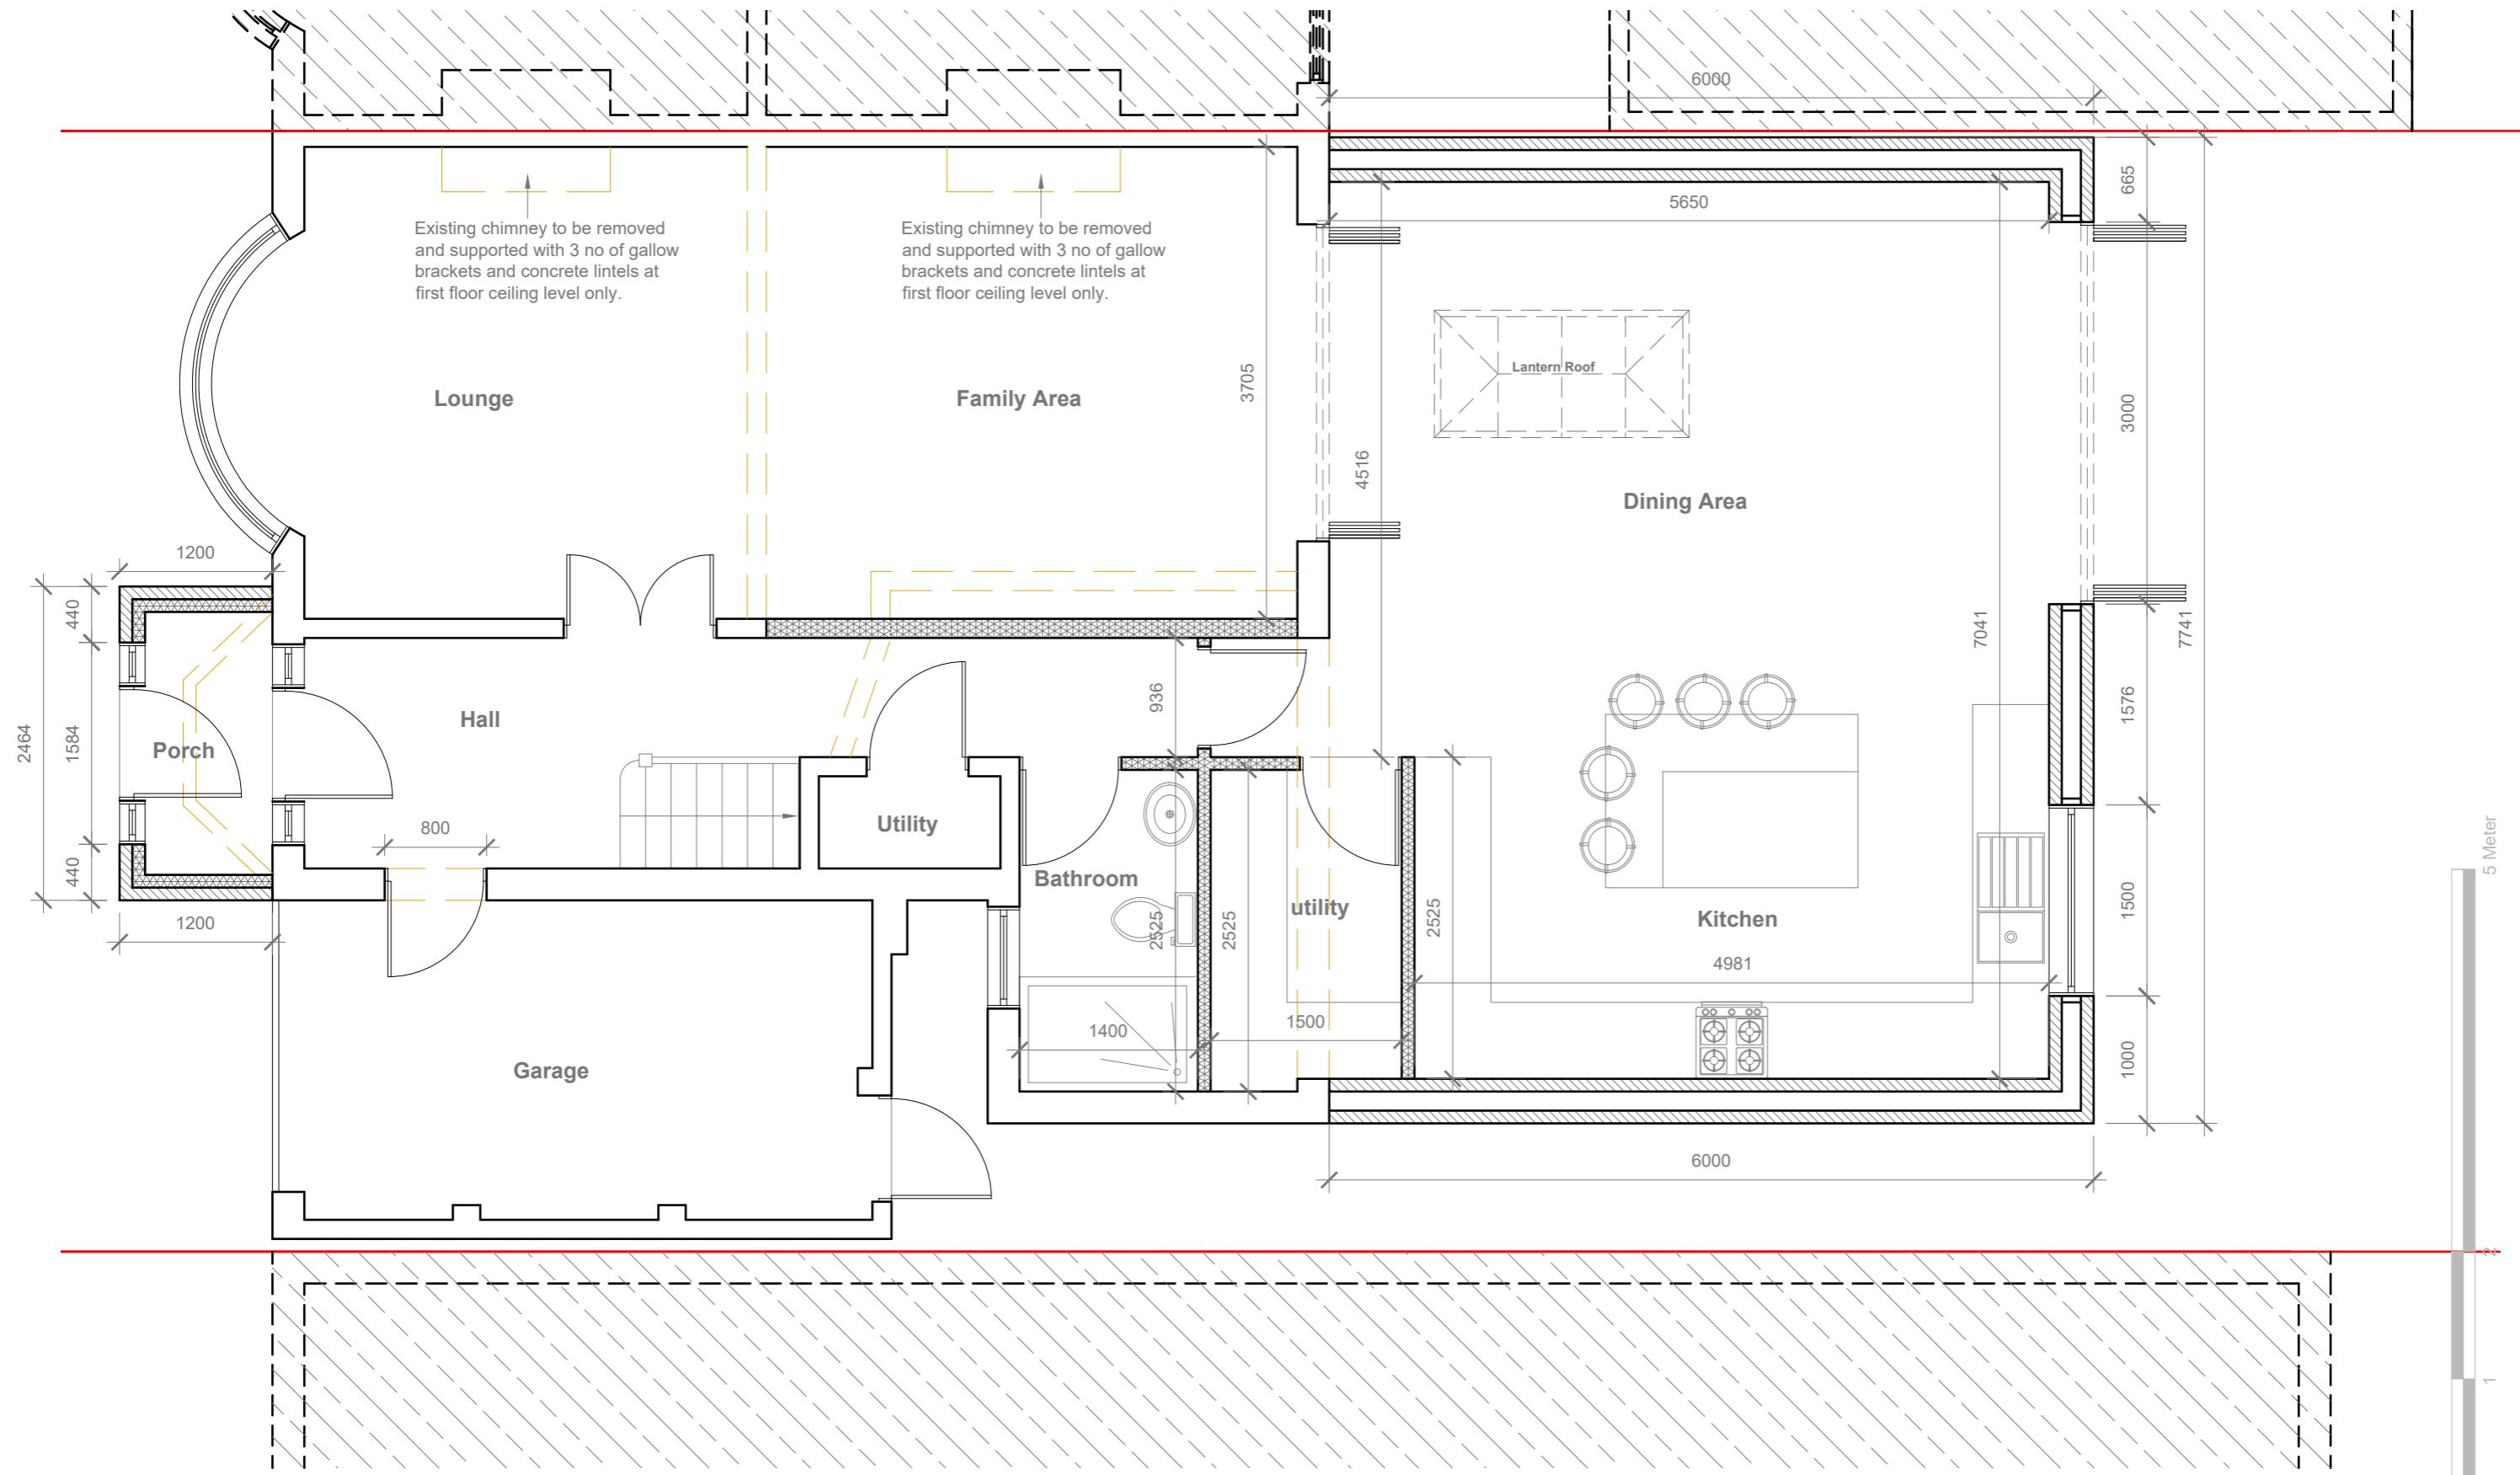

Proposed Ground Floor Plan

Scale 1:50

GENERAL NOTES:

1. ALL DIMENSIONS ARE IN MILLIMETER.
2. VERIFY ALL DIMENSIONS AND CONDITIONS BEFORE BUILDING OR STARTING CONSTRUCTION. NOTIFY THE DESIGNER IMMEDIATELY OF ANY DISCREPANCY OR VARIATION.
3. ALL WORK TO COMPLY WITH CURRENT BUILDING REGULATIONS AND CODES OF PRACTICE

Title:

Proposed Ground Floor Plan

Site Address

11 Newnham Avenue
Eastcote.
HA4 9RW

Scale: 1:50 @A3

Date: 26/11/2024
Drawing No.: 2024/190 -02

Revision Date:

Drawn By:
RO

1:50

0 1 2 3 4 5
Faluck Patel




Proposed Front Elevation

Scale 1:100

Proposed Side Elevation

Scale 1:100

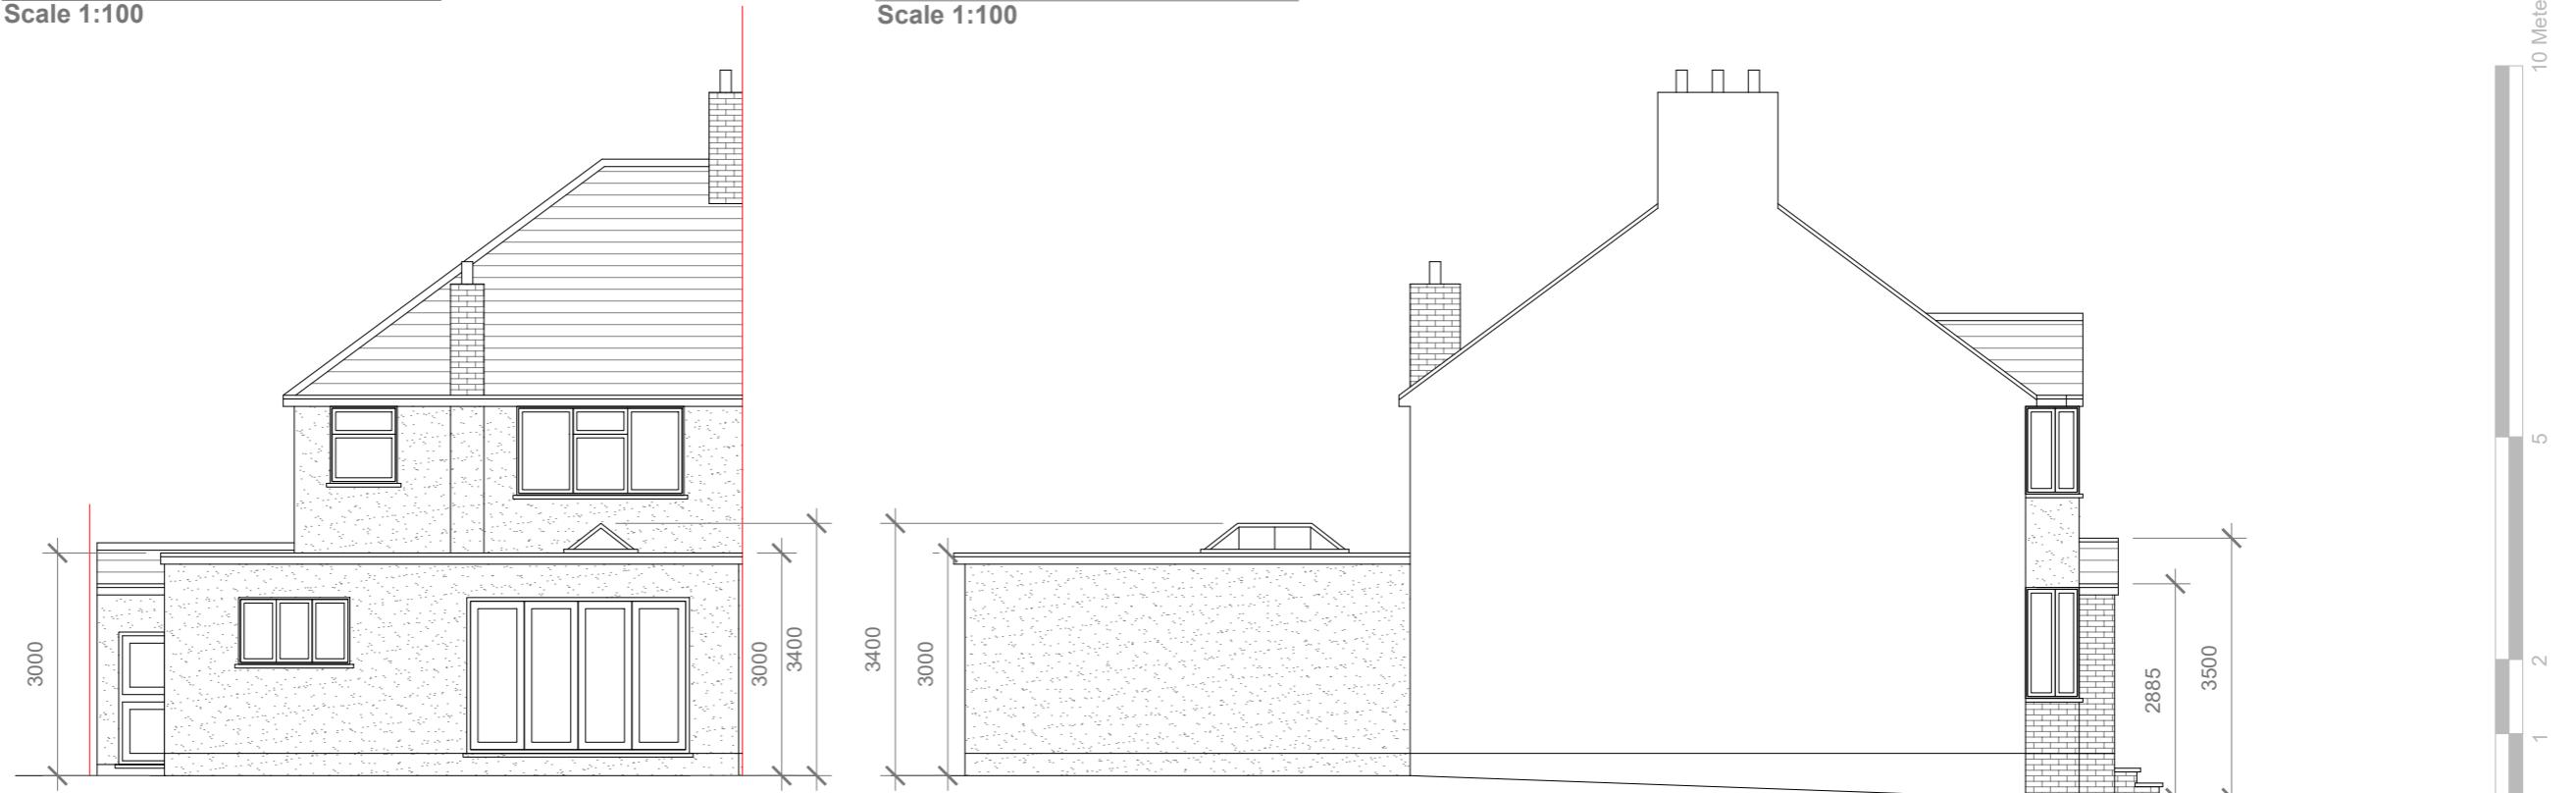

Proposed Rear Elevation

Scale 1:100

Proposed Side Elevation

Scale 1:100

GENERAL NOTES:
 1. ALL DIMENSIONS ARE IN MILLIMETER.
 2. VERIFY ALL DIMENSIONS AND CONDITIONS BEFORE BUILDING OR
 STARTING CONSTRUCTION. NOTIFY THE DESIGNER IMMEDIATELY OF ANY
 DISCREPANCY OR VARIATION.
 3. ALL WORK TO COMPLY WITH CURRENT BUILDING REGULATIONS
 AND CODES OF PRACTICE

Title: _____

Proposed Elevations

Site Address
 11 Newnham Avenue
 Eastcote.
 HA4 9RW

Scale: 1:100 @A3
 Date: 26/11/2024
 Drawing No.: 2024/190 -03
 Drawn By: RO

Revision Date: _____
 e:mail - faluckpatel@yahoo.com
 (M) +44 (0) 7871 466 254

Faluck Patel