




11 Existing Front Elevation
Scale 1:100

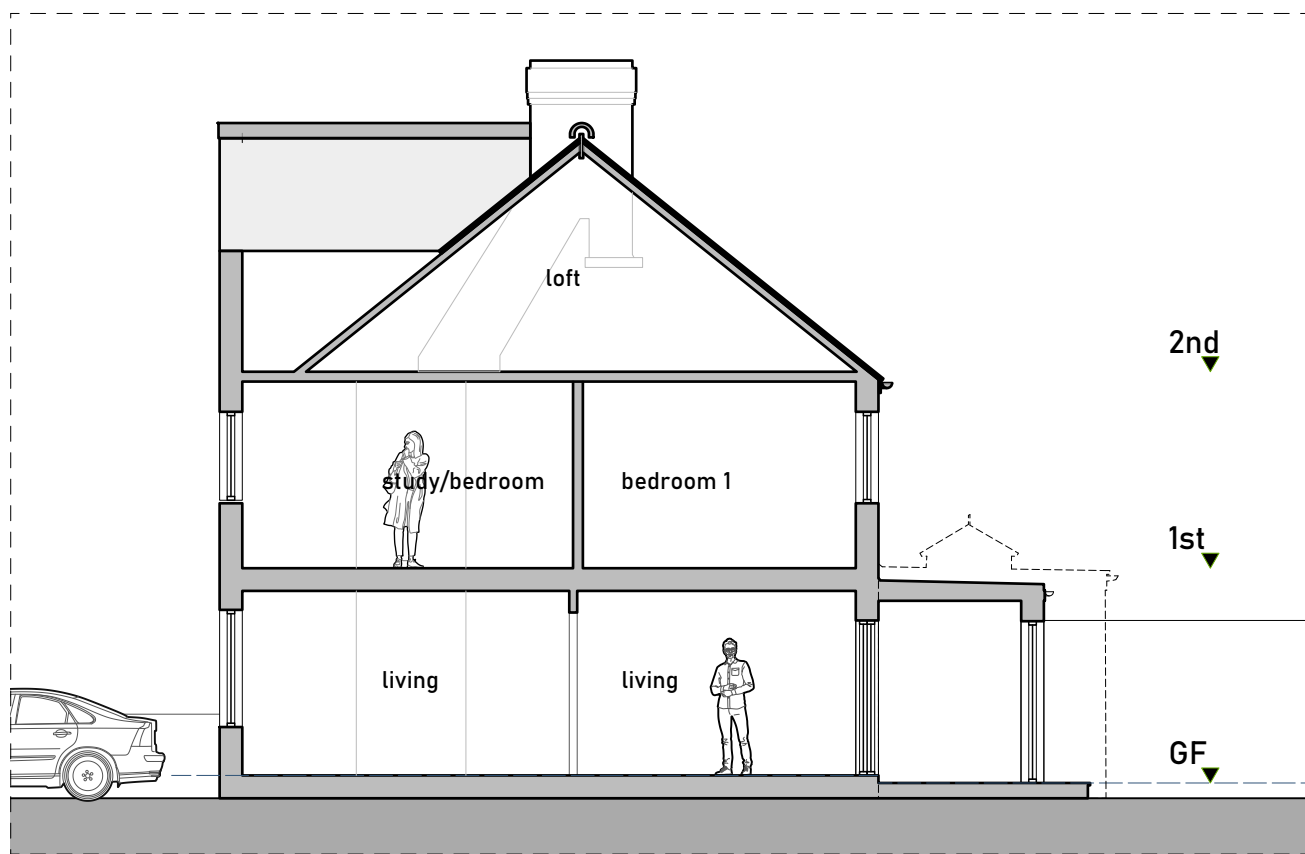


12 Existing Section A-A
Scale 1:100

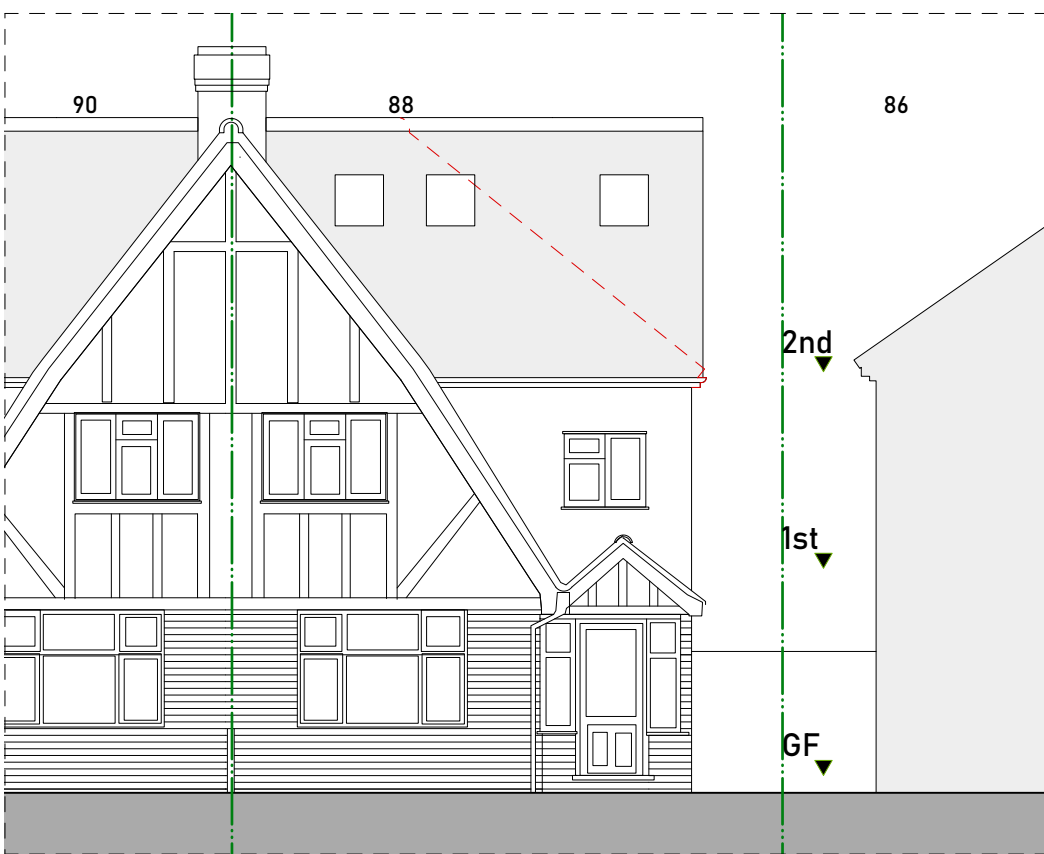


13 Proposed Front Elevation
Scale 1:100

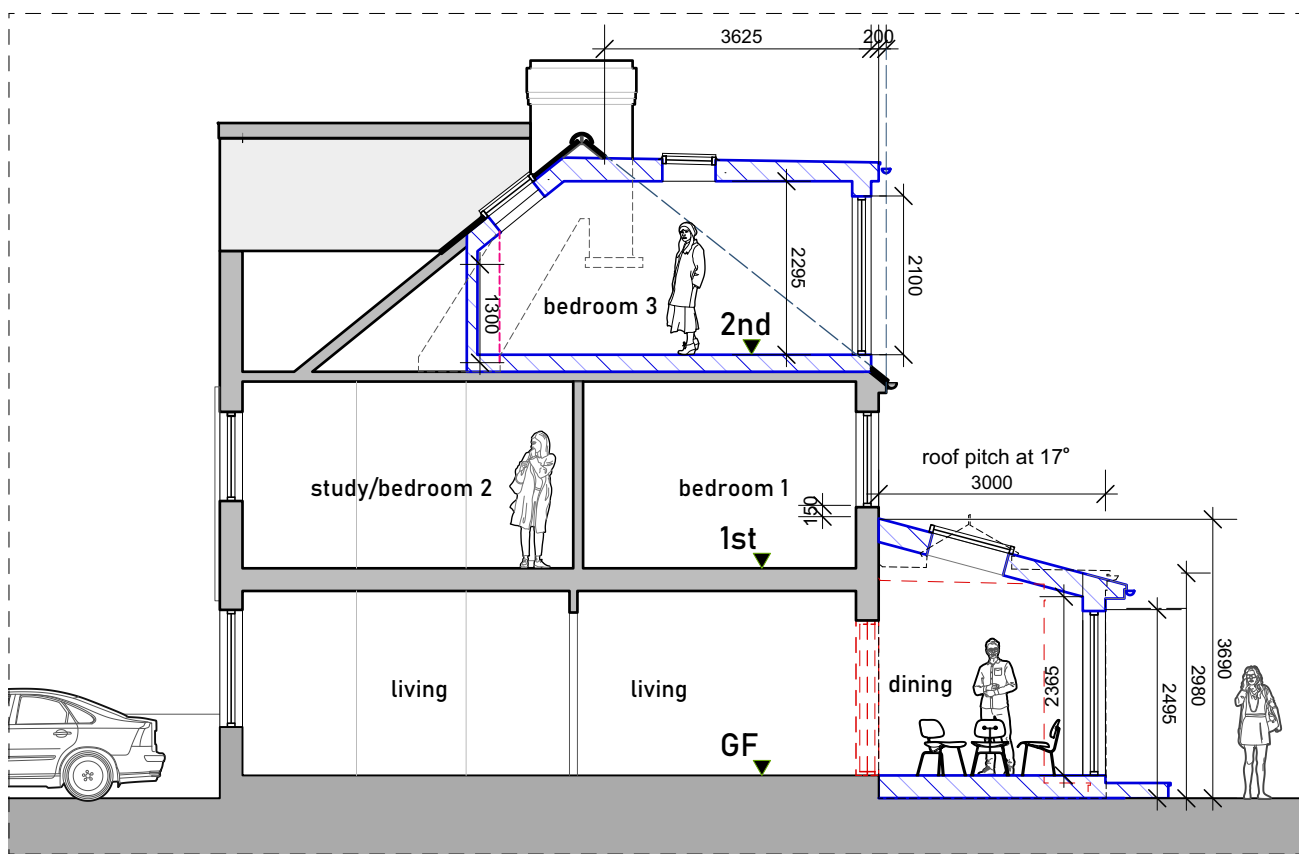


14 Proposed Section A-A
Scale 1:100

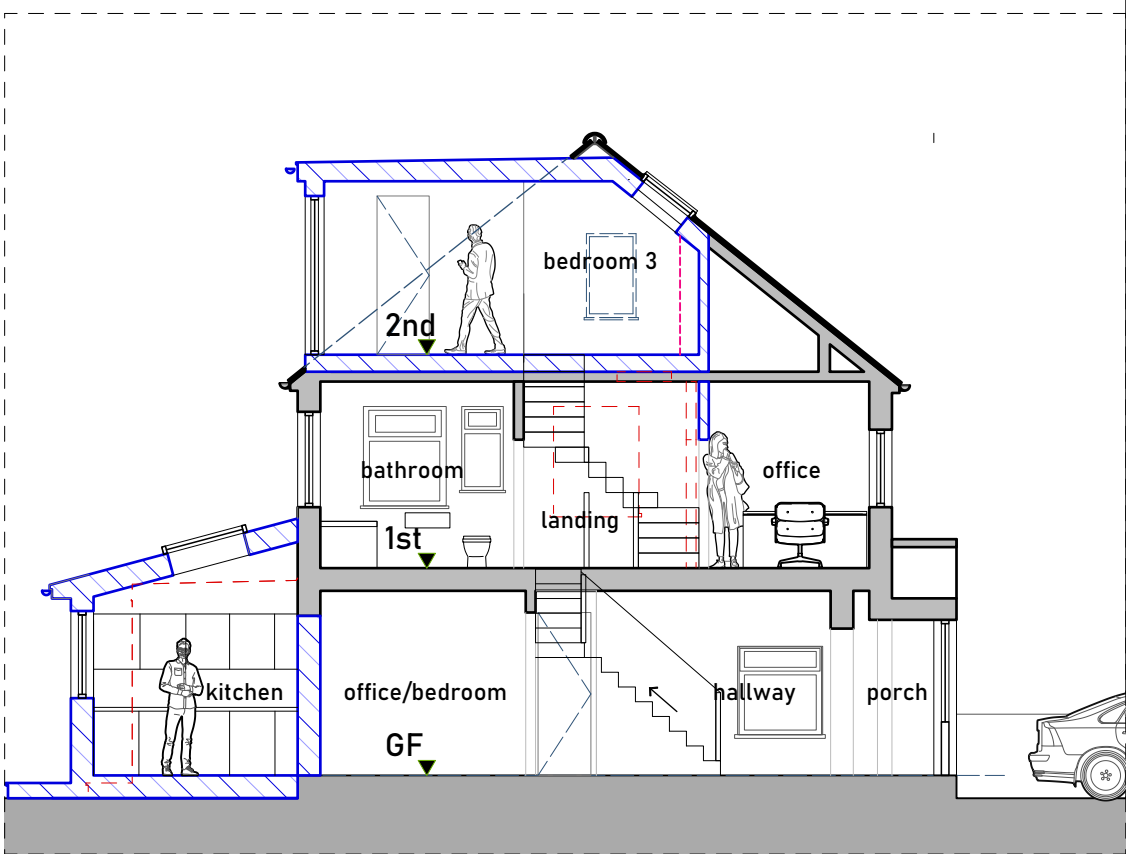


15 Proposed Section B-B
Scale 1:100

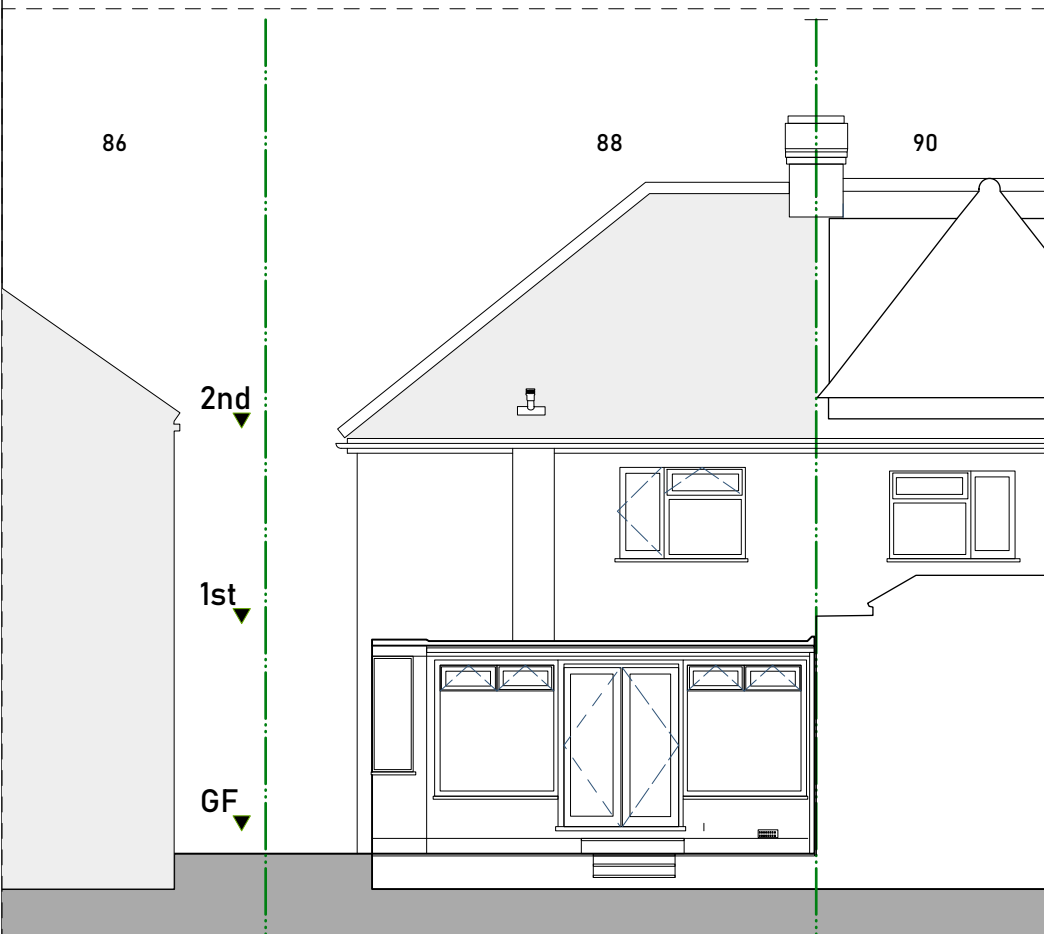


07 Existing Rear Elevation
Scale 1:100

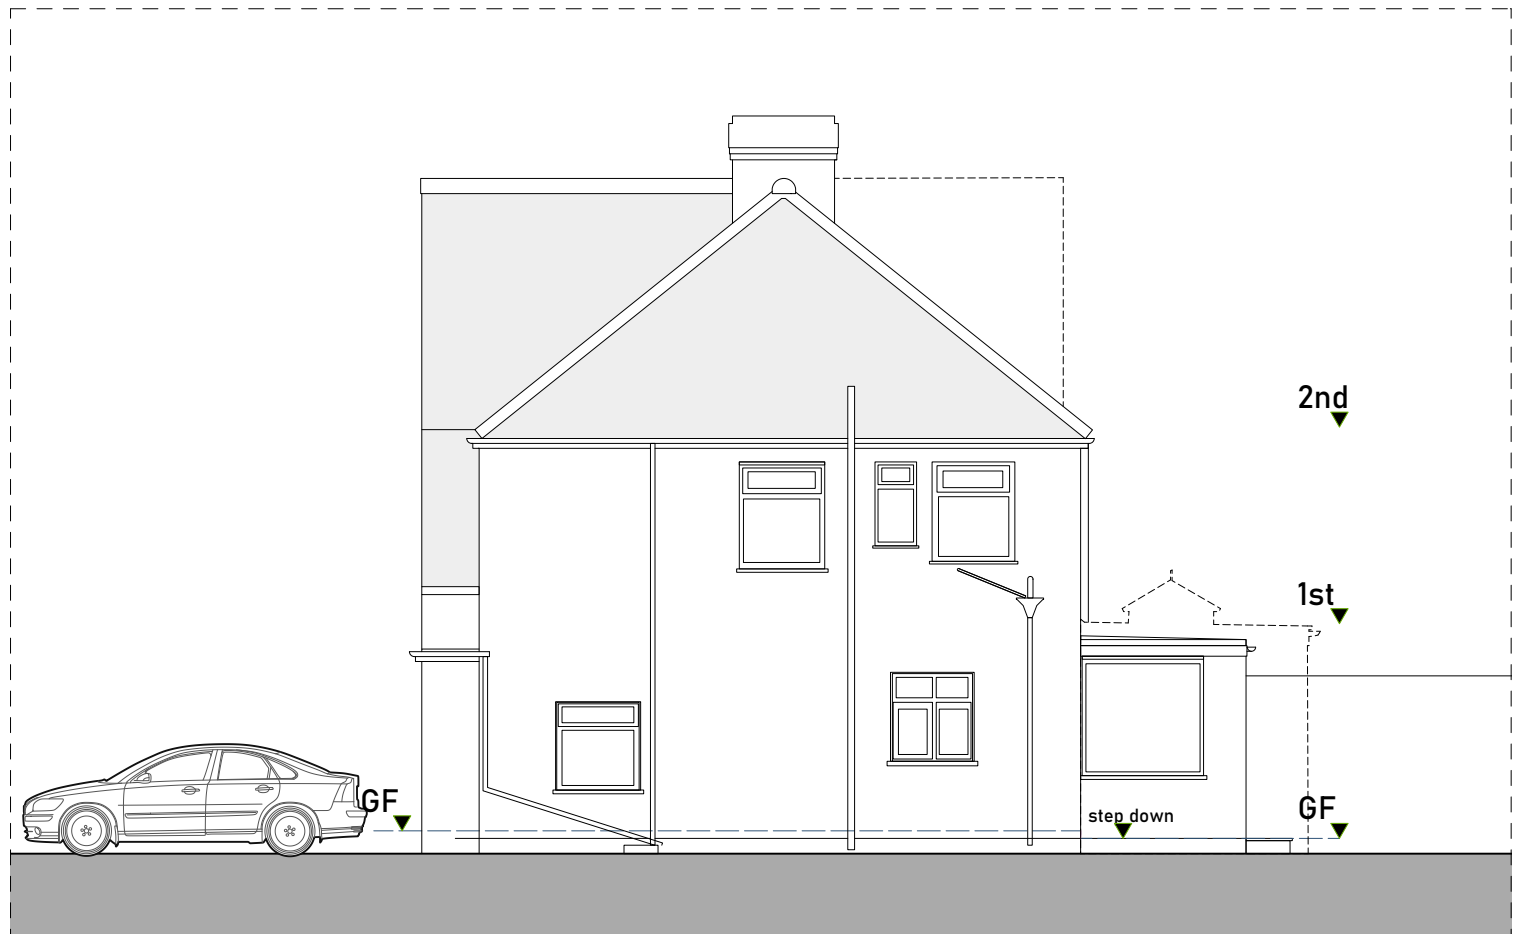

08 Existing Side Elevation
Scale 1:100

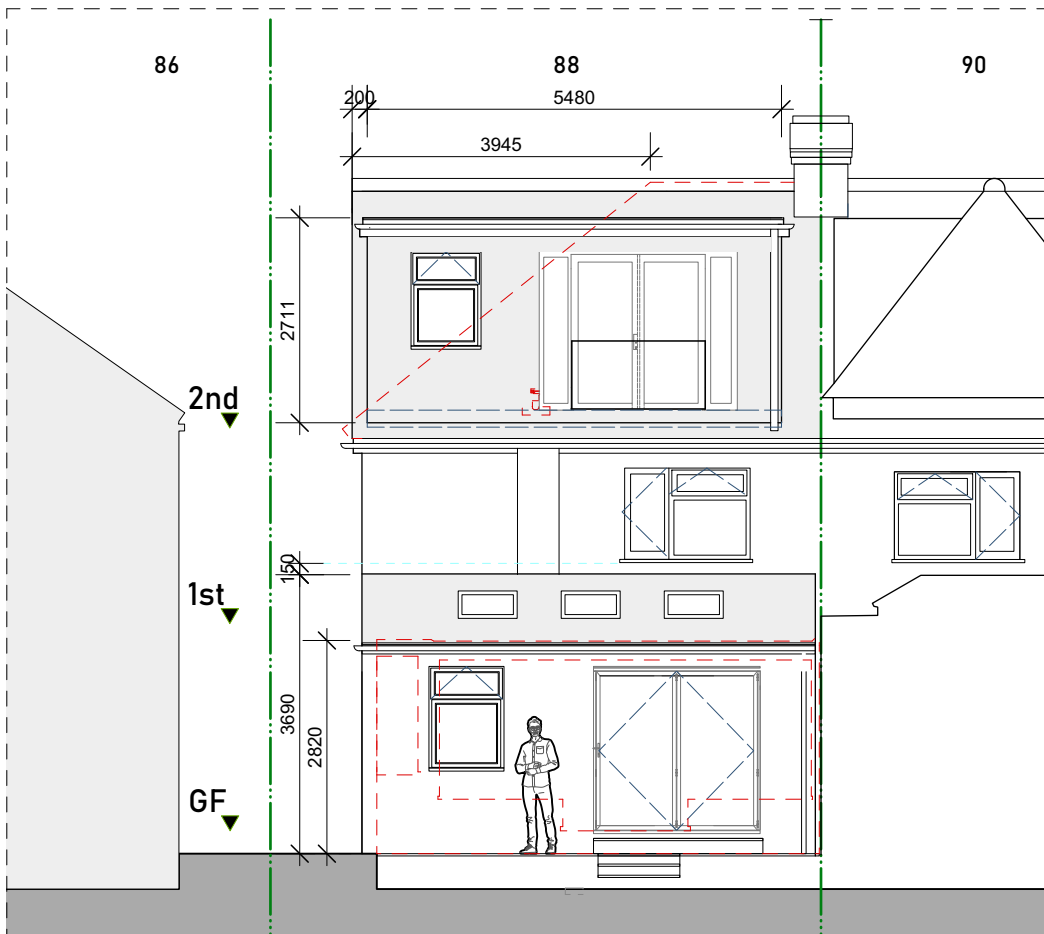


09 Proposed Rear Elevation
Scale 1:100

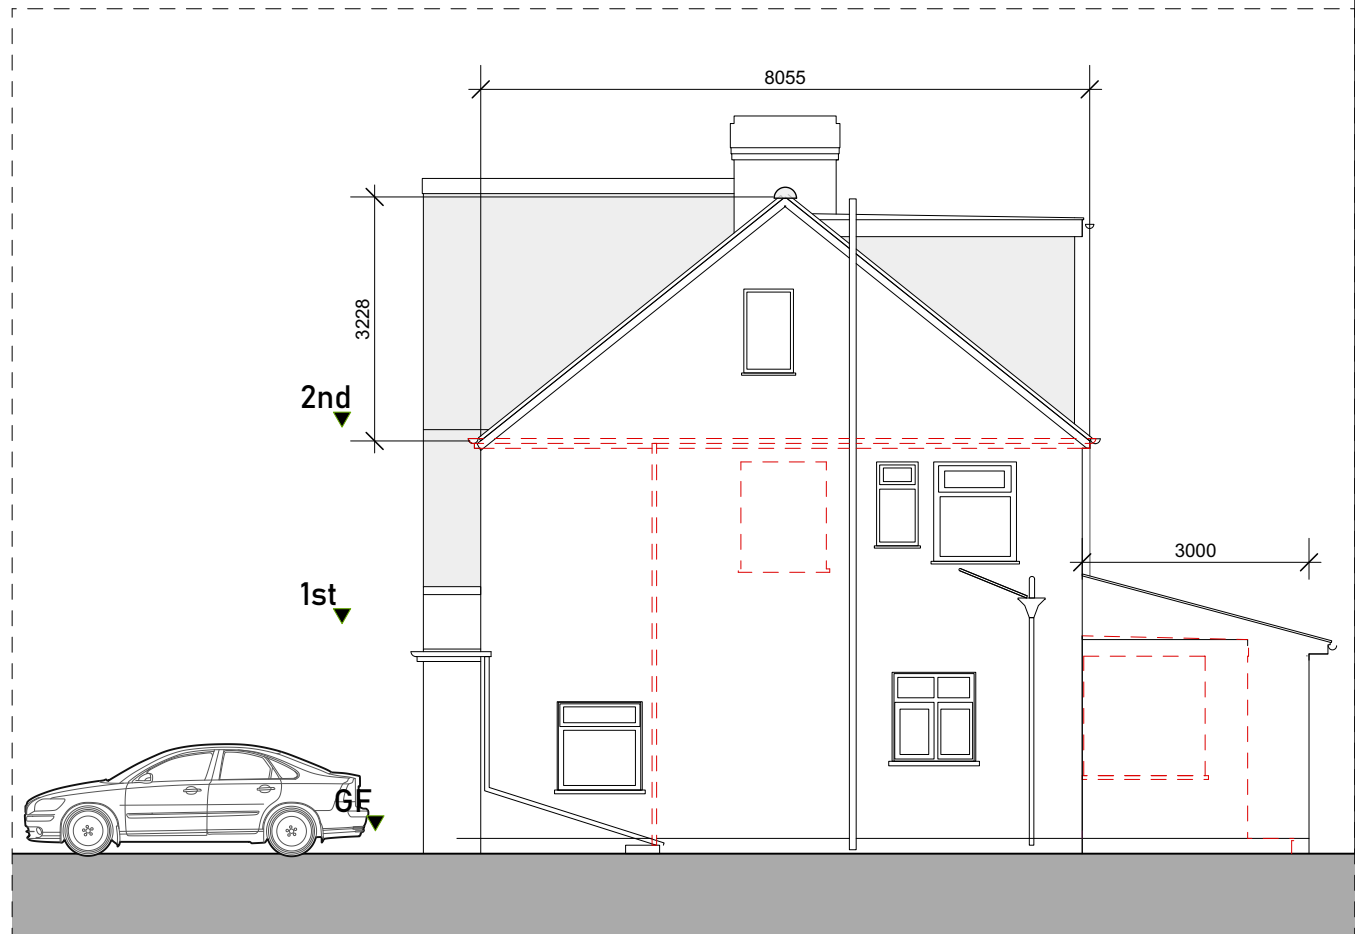


10 Proposed Side Elevation
Scale 1:100

All materials to be similar in appearance to existing


Rooflights not to protrude 150 above roof slope

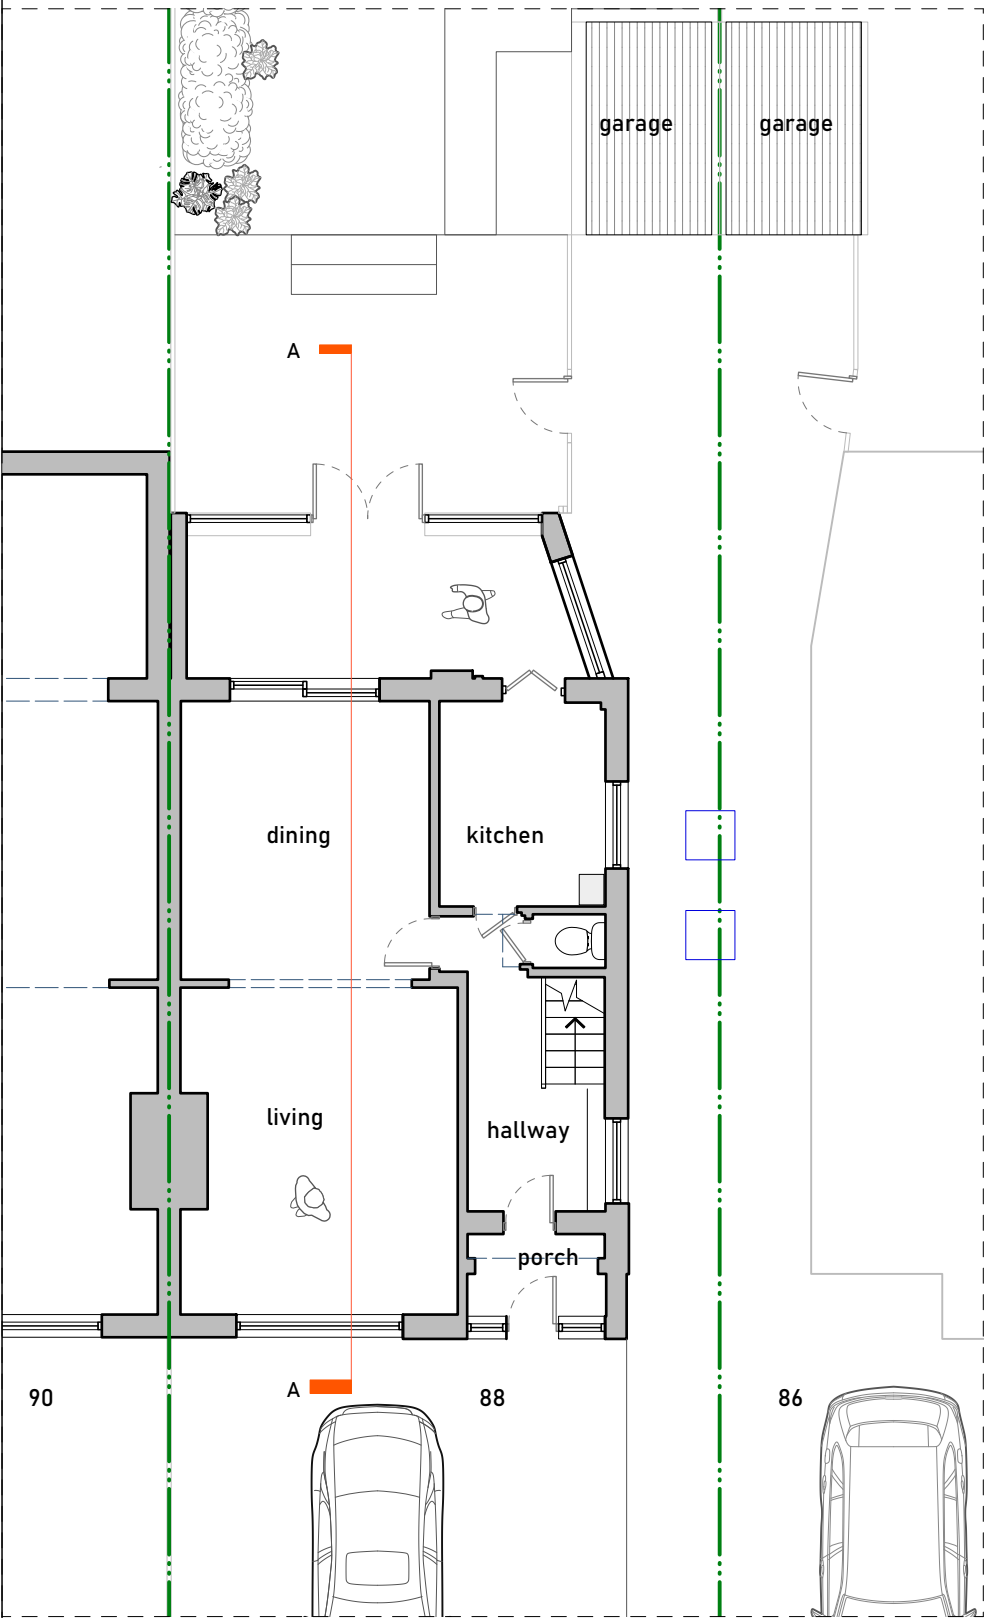


01 Existing Ground Floor Plan
Scale 1:100

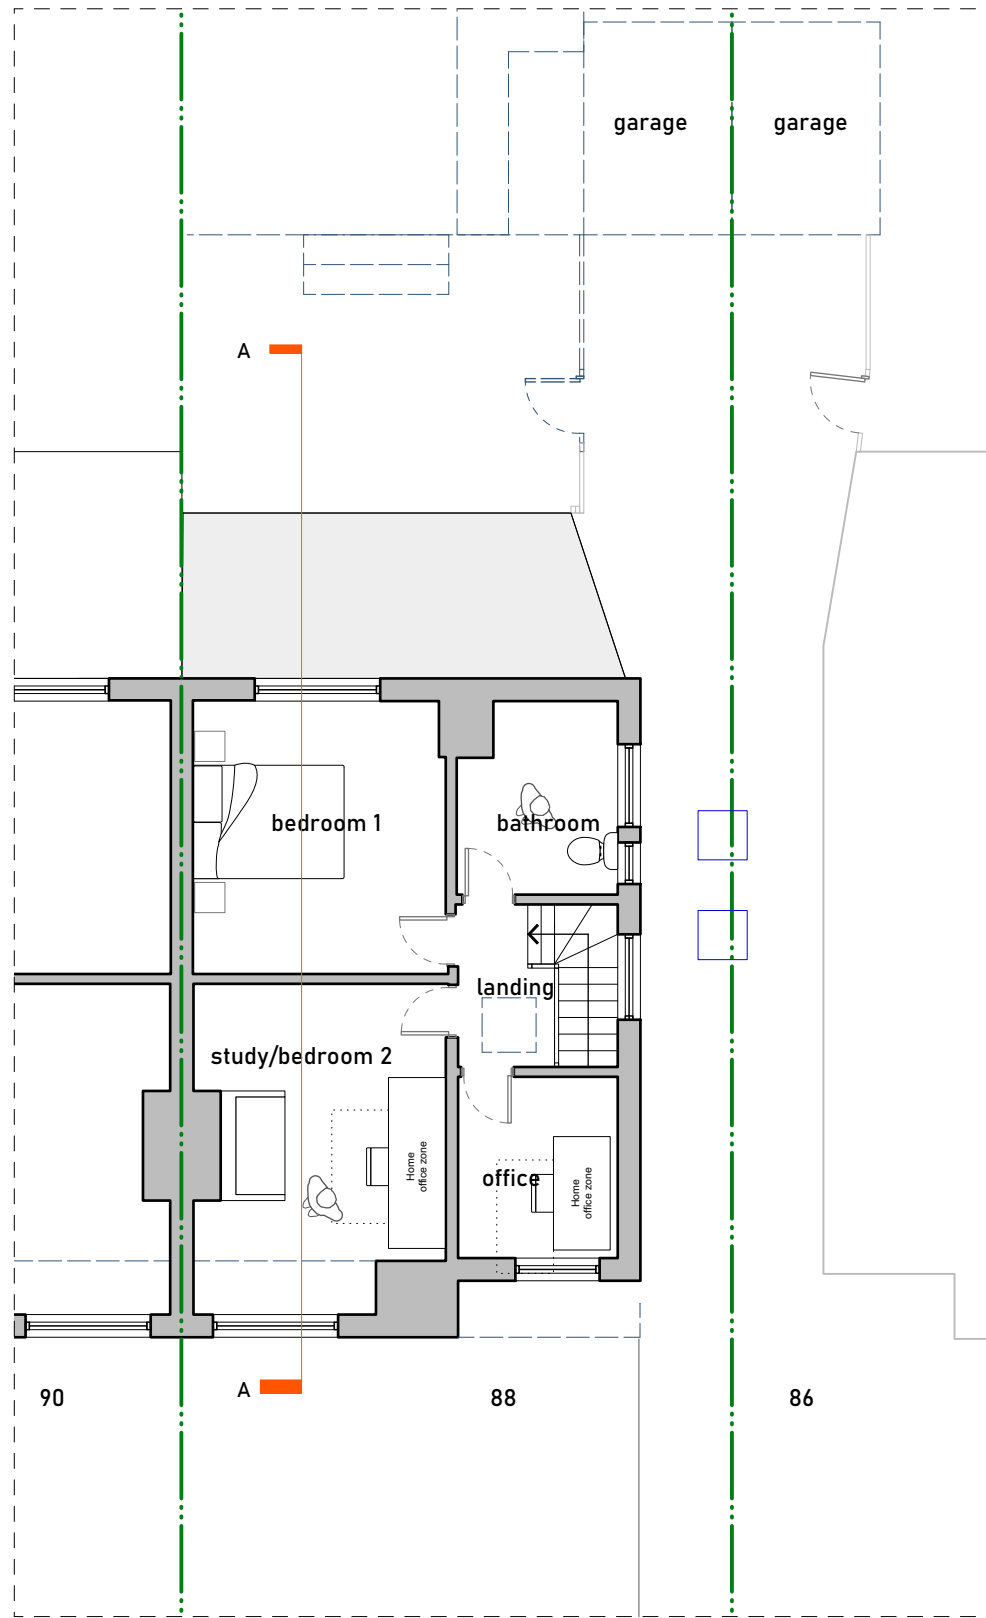


02 Existing First Floor Plan
Scale 1:100

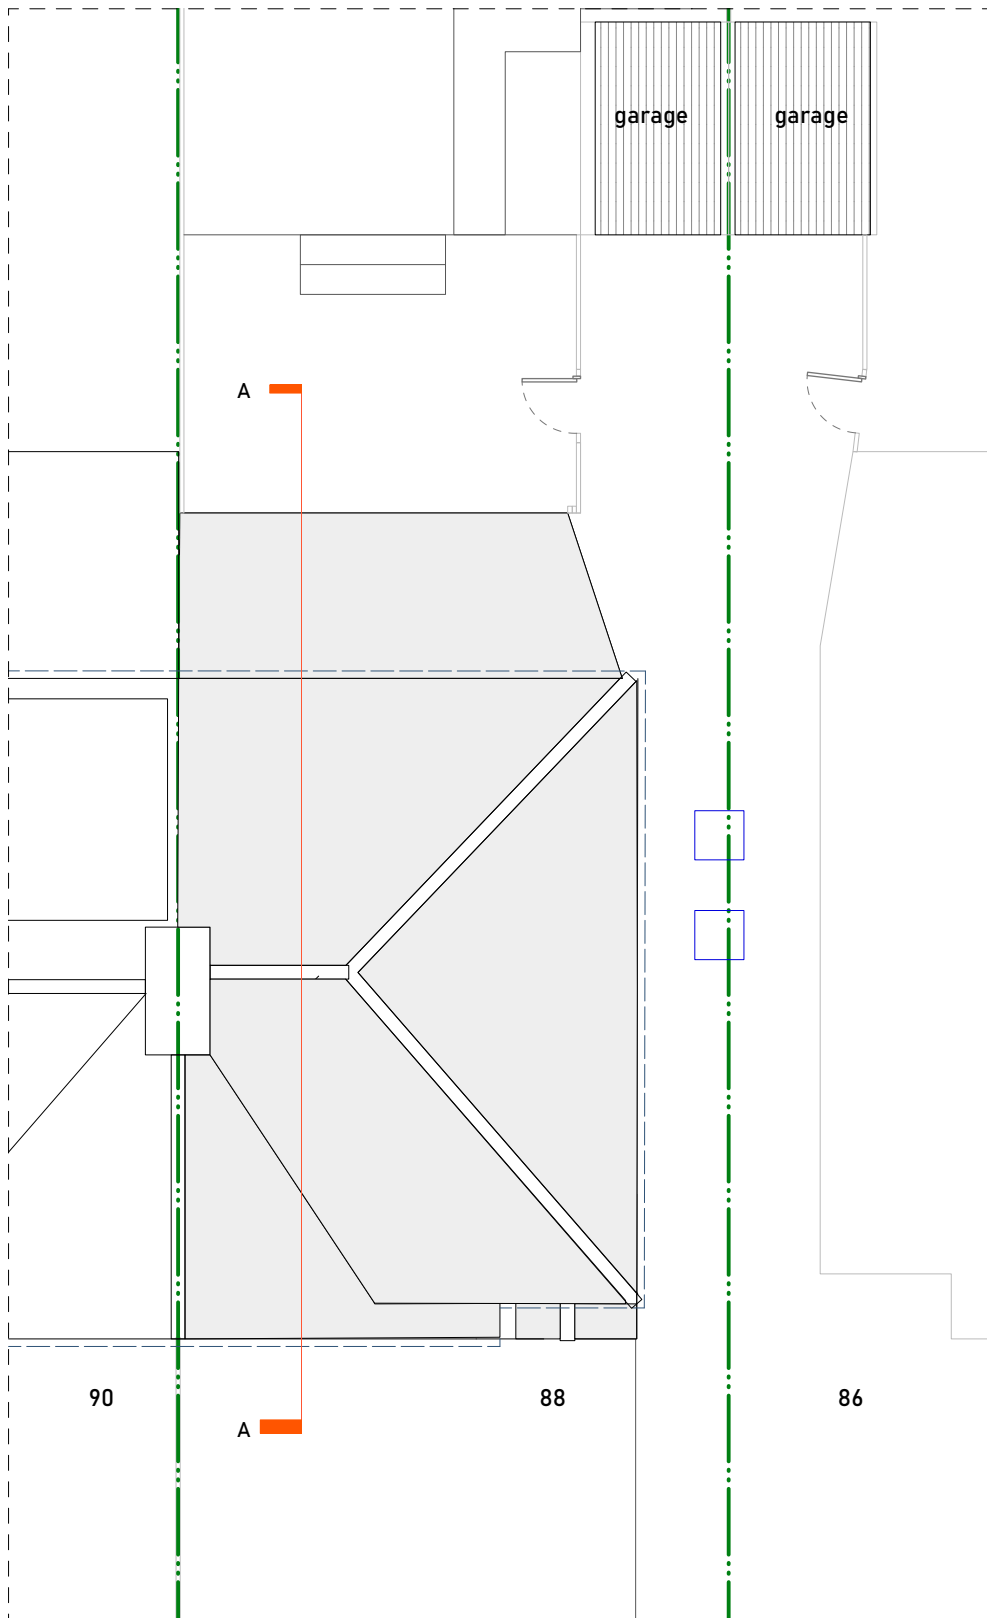


03 Existing Roof Plan
Scale 1:100

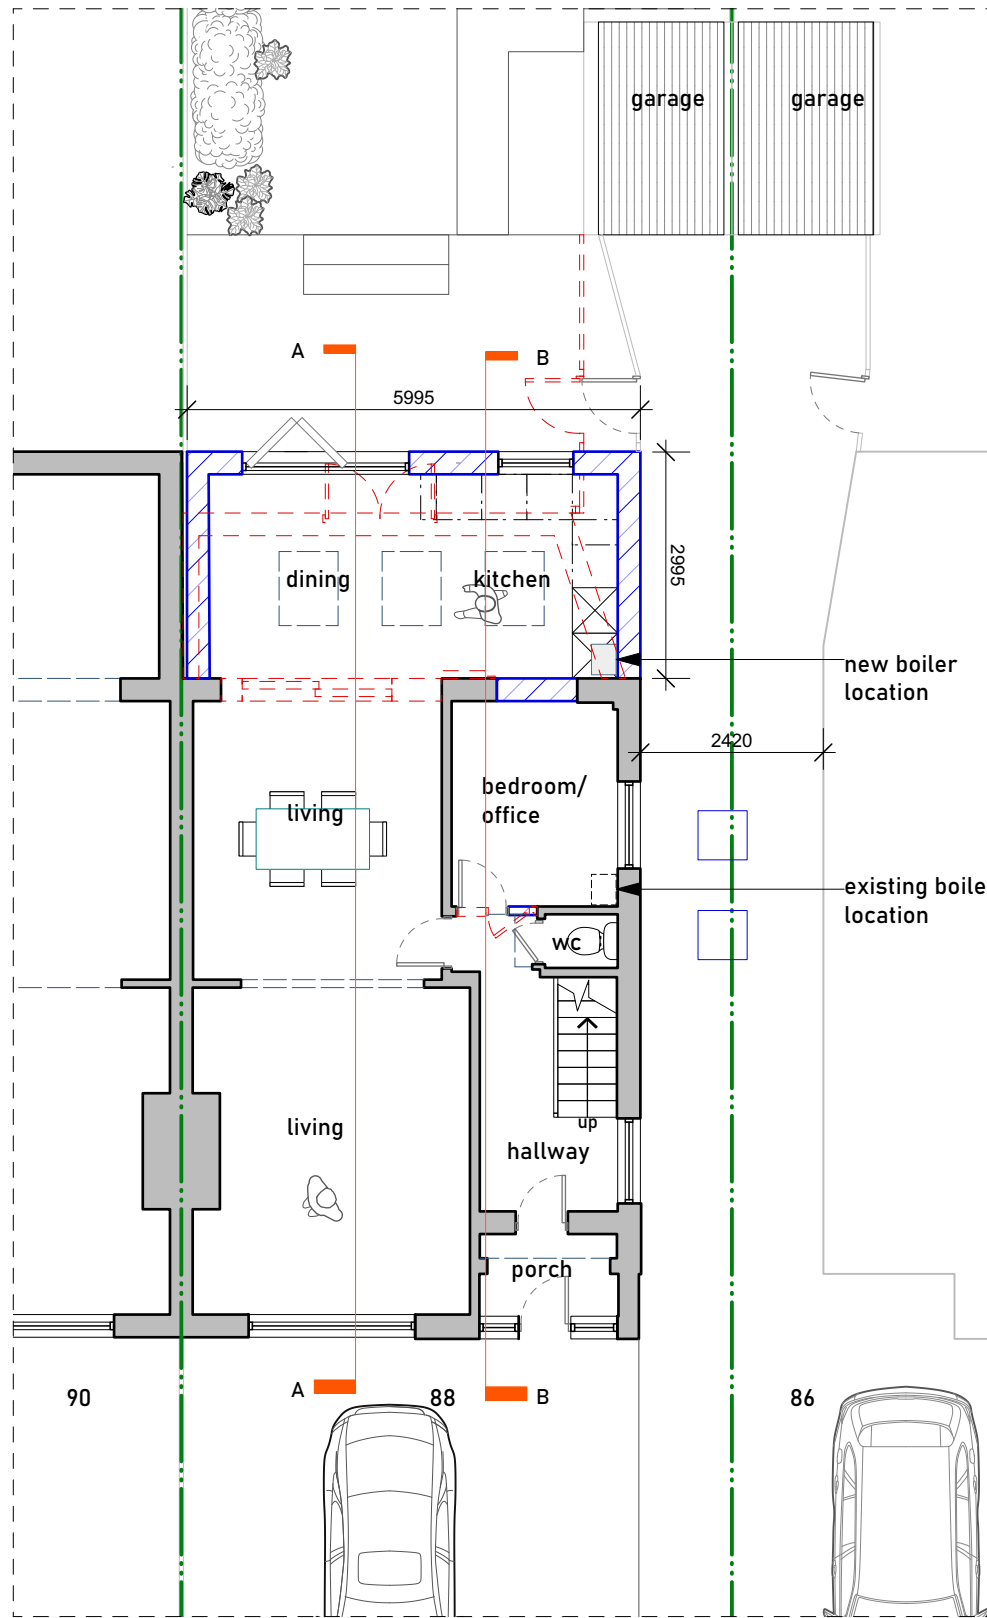

04 Proposed Ground Floor Plan
Scale 1:100

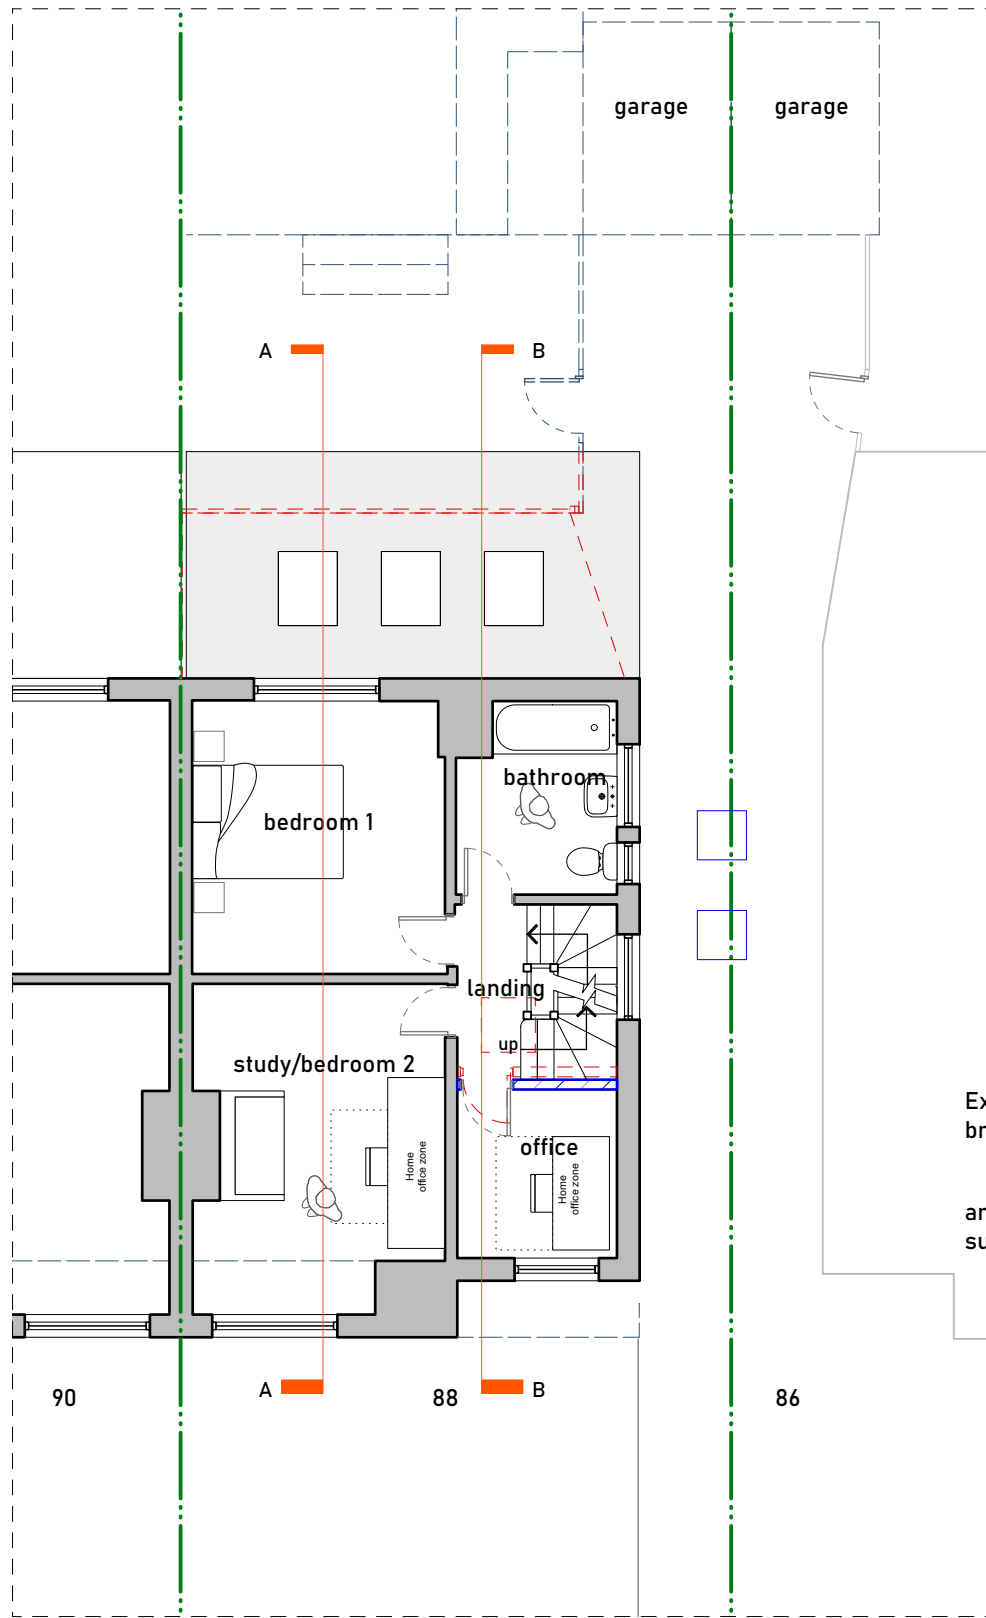

05 Proposed First Floor Plan
Scale 1:100

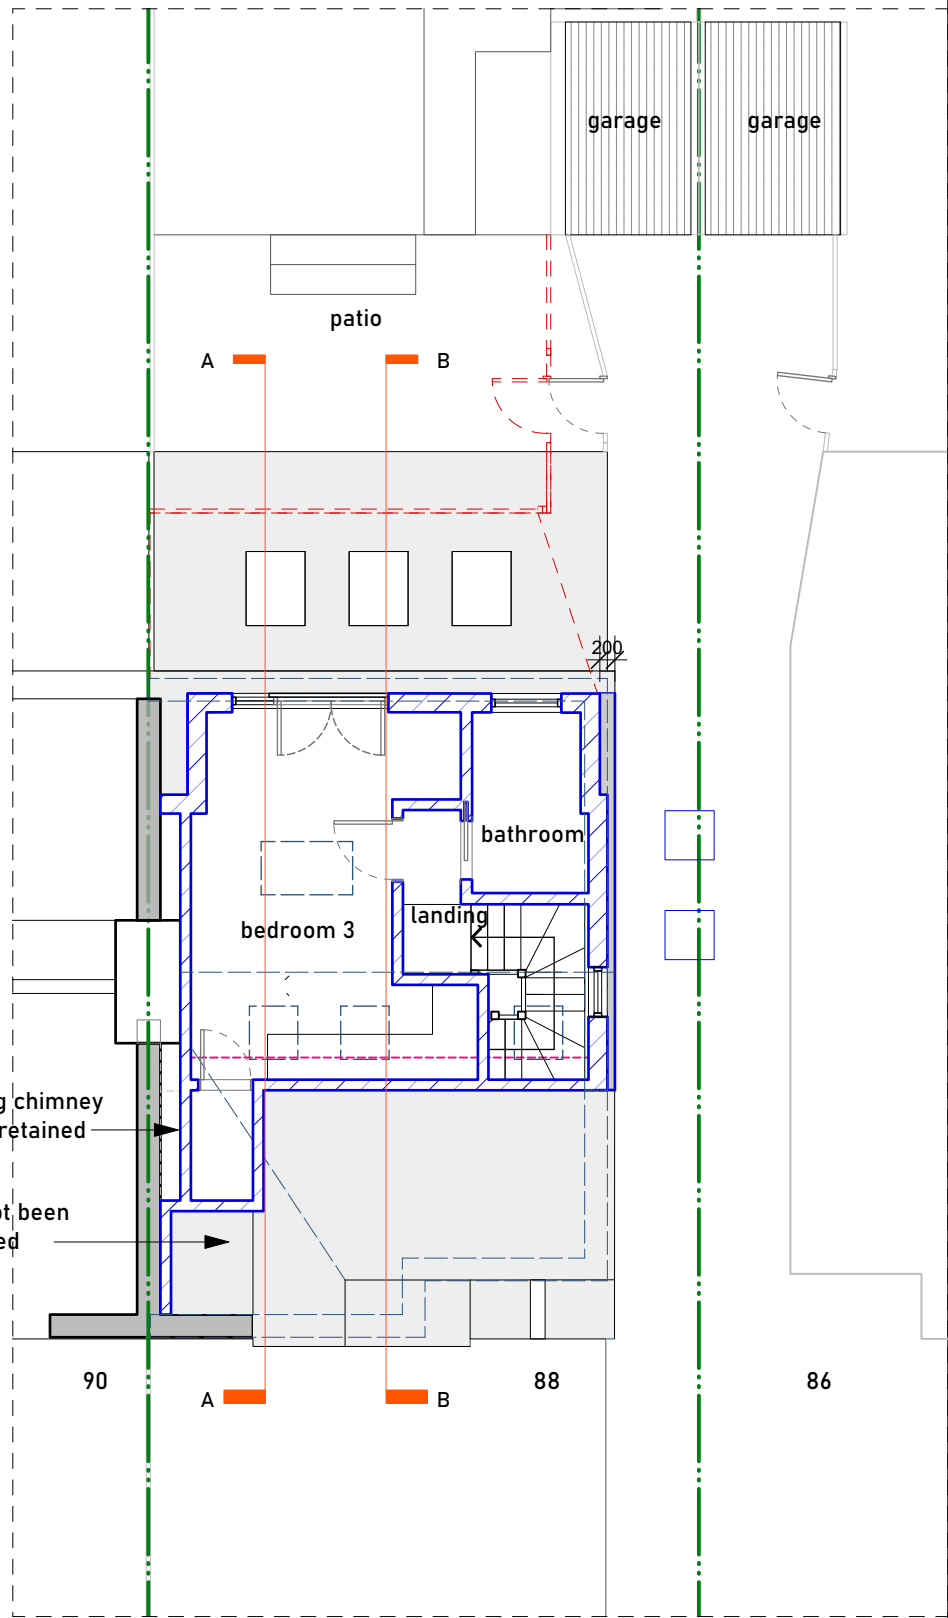

06 Proposed Loft Plan
Scale 1:100

DRAWING NOTES:

All dimensions to be checked on site prior to commencement of any works, and/or preparation of any shop drawings.

Sizes of and dimensions to any structural elements are indicative only. See structural engineers drawings for actual sizes/dimensions.

Sizes of and dimensions to any service elements are indicative only. See service engineers drawings for actual sizes and dimensions.

This drawing to be read in conjunction with all other Architect's drawings, specifications and other Consultants' information.

All proprietary systems shown on this drawing are to be installed strictly in accordance with the Manufacturers/Suppliers recommended details.

Any discrepancies between information shown on this drawing and any other contract information or manufacturers/suppliers recommendations is to be brought to the attention of the Architect.

DO NOT SCALE FROM THIS DRAWING.

DRAWING NOTES:

Site Boundary

Proposed Walls


Floor and ceiling levels

Demolished

+ existing site level

+ new level

0 5 10 M

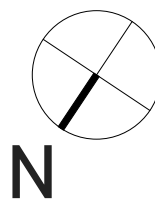

STATUS REVISION

DATE

DRAWING
Existing & Proposed Drawings

SCALE 1:100 @ A1

DATE 21/07/2022

DWG No. 623-P-1

DRAWING STATUS PLANNING

CHECKED BY JD

DRAWN BY OAK

REVISION -

Jack Dušek & Co.

CLIENT Abelardo Polonio

PROJECT 88 West Mead, Ruislip, HA4 0TN