

Existing Ground Floor Plan
Scale 1:100



GENERAL NOTES:
1. ALL DIMENSIONS ARE IN MILLIMETER.
2. VERIFY ALL DIMENSIONS AND CONDITIONS BEFORE BUILDING OR STARTING CONSTRUCTION. NOTIFY THE DESIGNER IMMEDIATELY OF ANY DISCREPANCY OR VARIATION.
3. ALL WORK TO COMPLY WITH CURRENT BUILDING REGULATIONS AND CODES OF PRACTICE

Title:

Existing Ground Floor Plan

Site Address

29 Green Lane,
Uxbridge.
UB8 3ED

Scale: 1:100 @A3

Date: 14/02/2025

Drawing No.:
2025/021 -01

Drawn By:
FP

Revision Date:

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**Faluck
Patel**



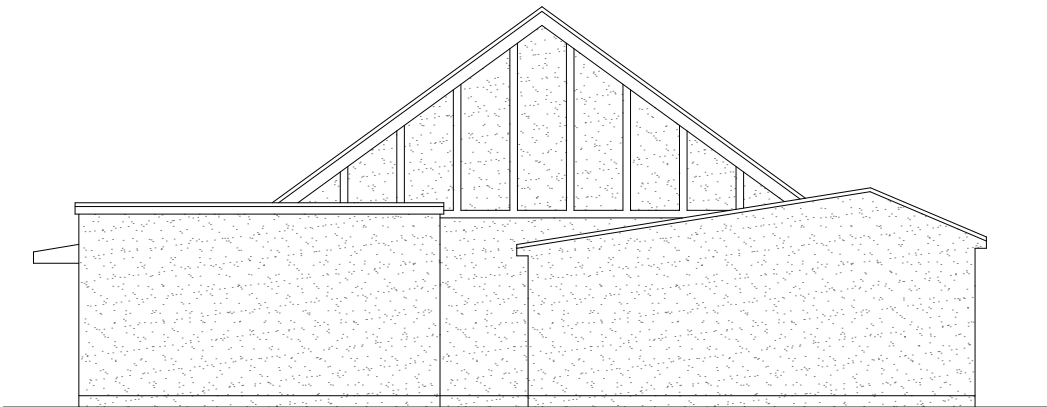
Existing Front Elevation
Scale 1:100



Existing Side Elevation
Scale 1:100



Existing Rear Elevation
Scale 1:100



Existing Side Elevation
Scale 1:100



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Title:

Existing Elevations

Site Address

29 Green Lane,
Uxbridge.
UB8 3ED

Scale: 1:100 @A3

Date: 14/02/2025

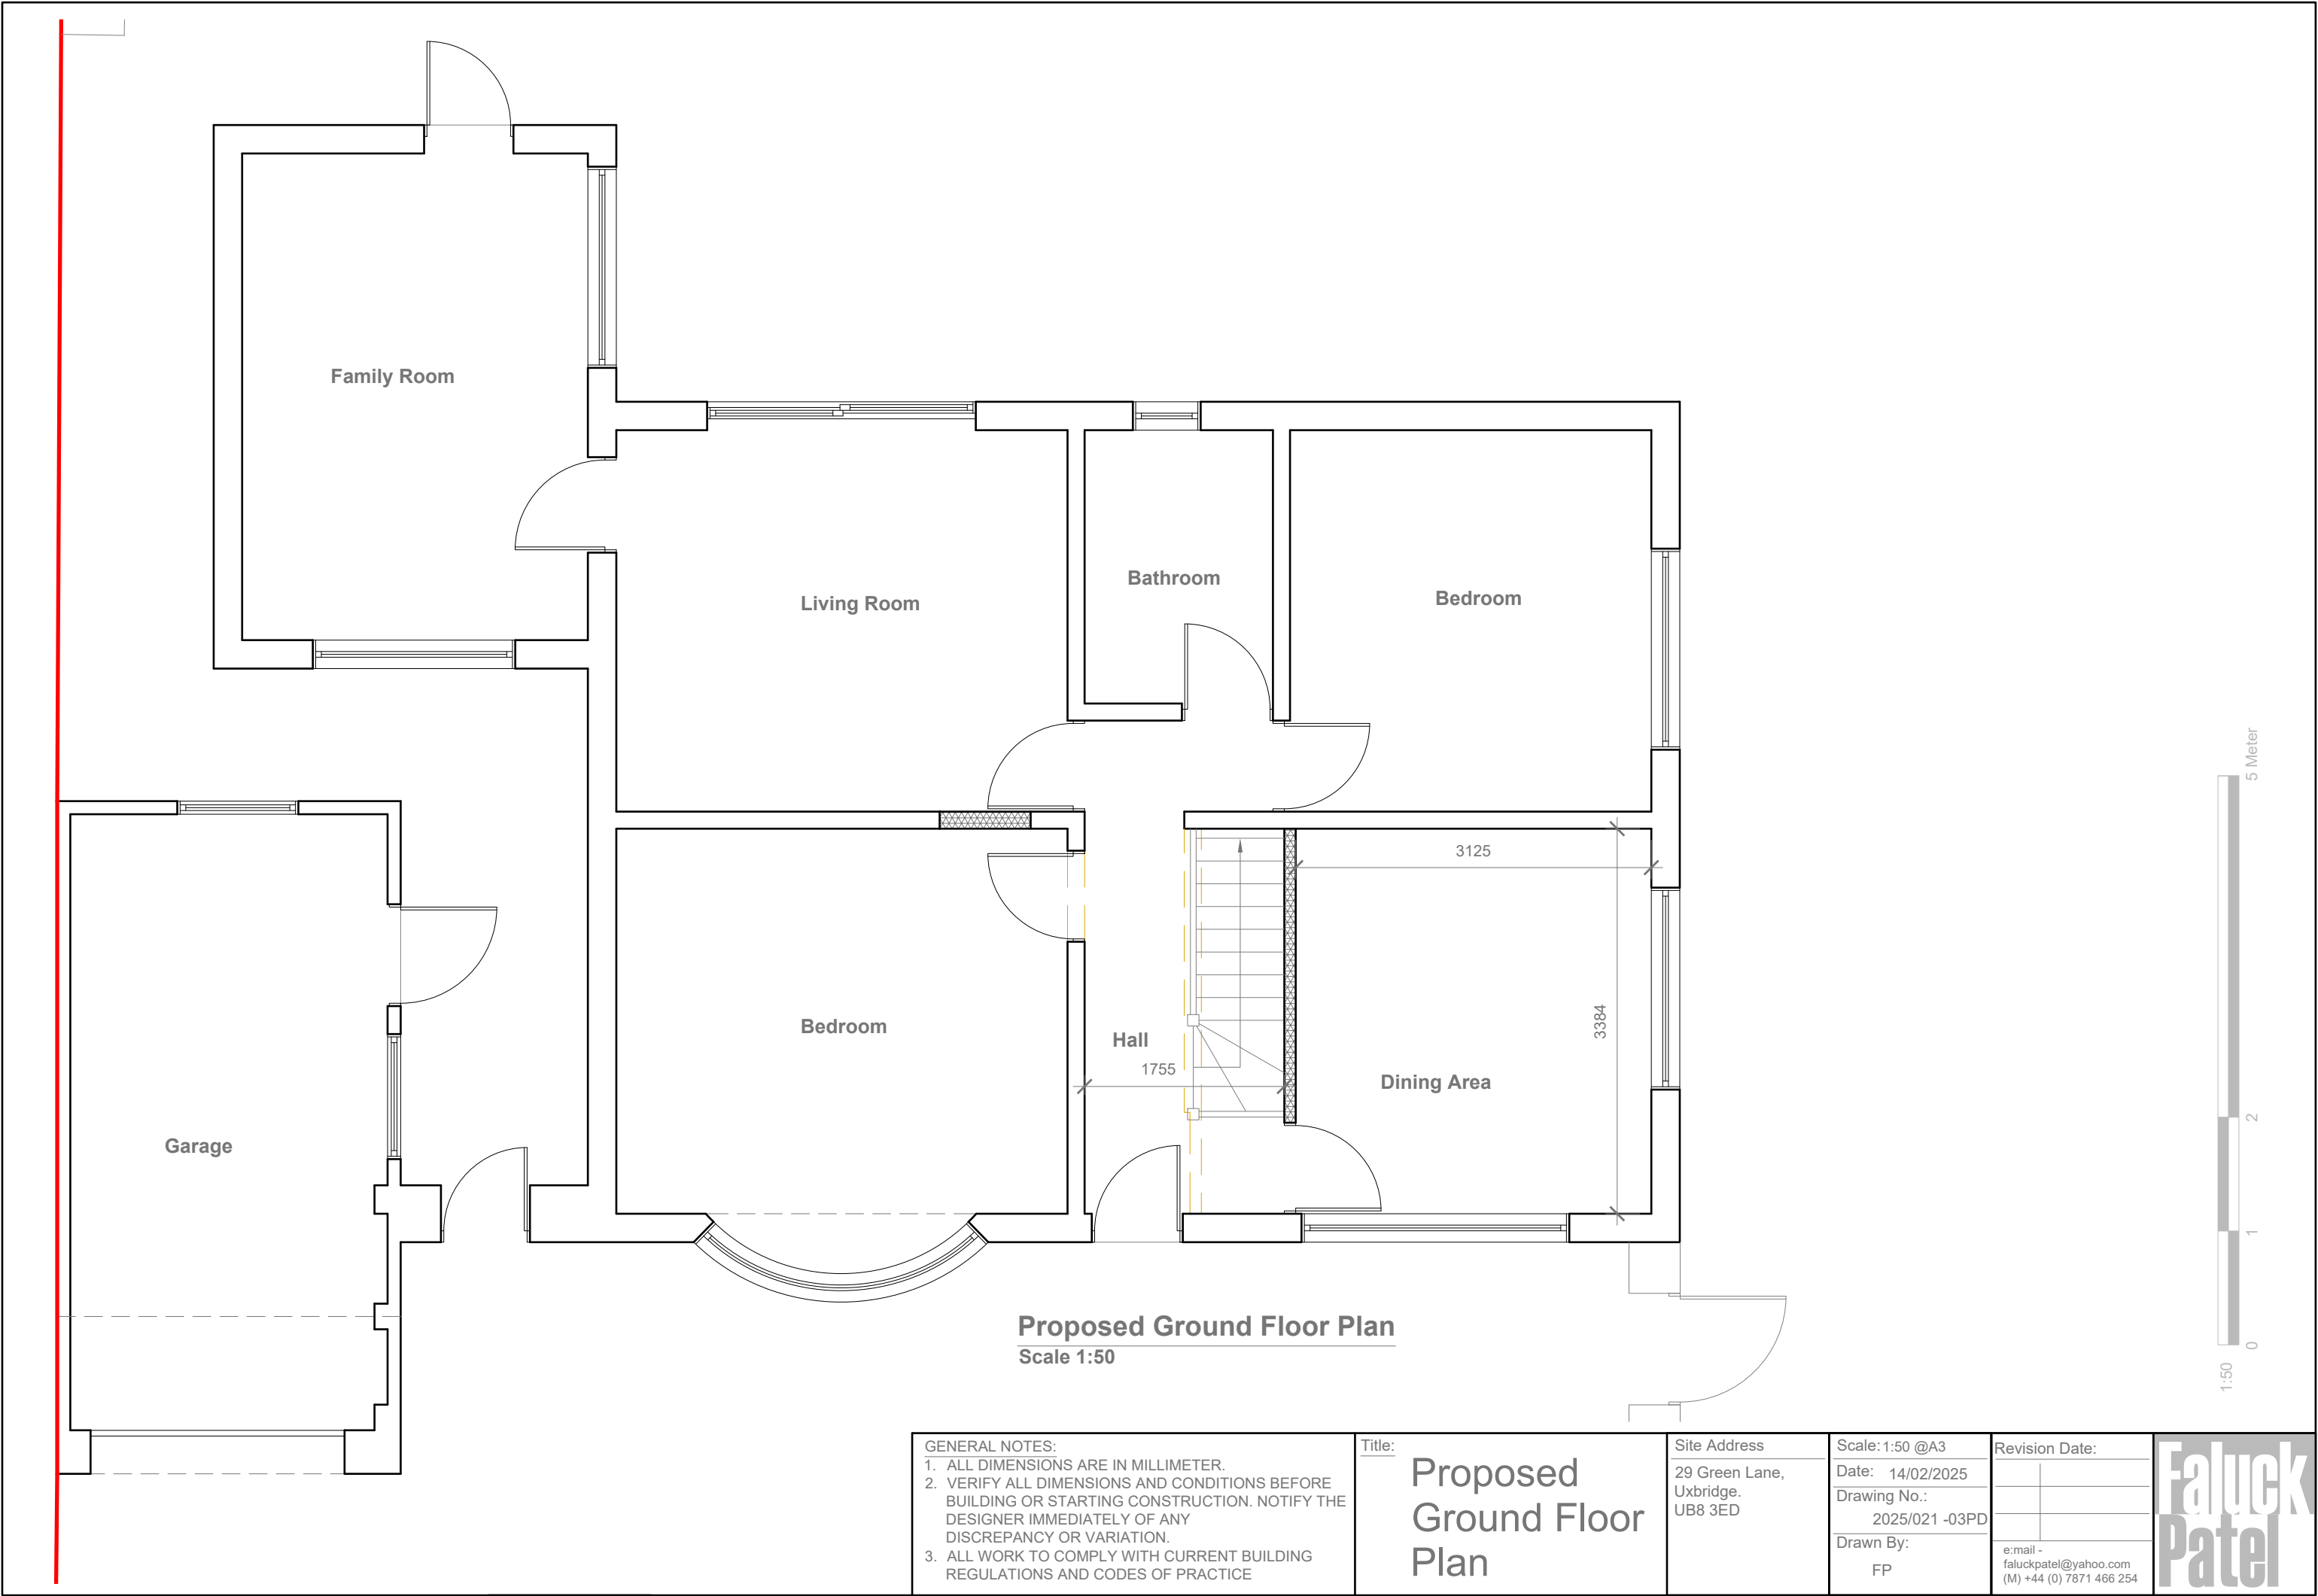
Drawing No.:
2025/021 -02

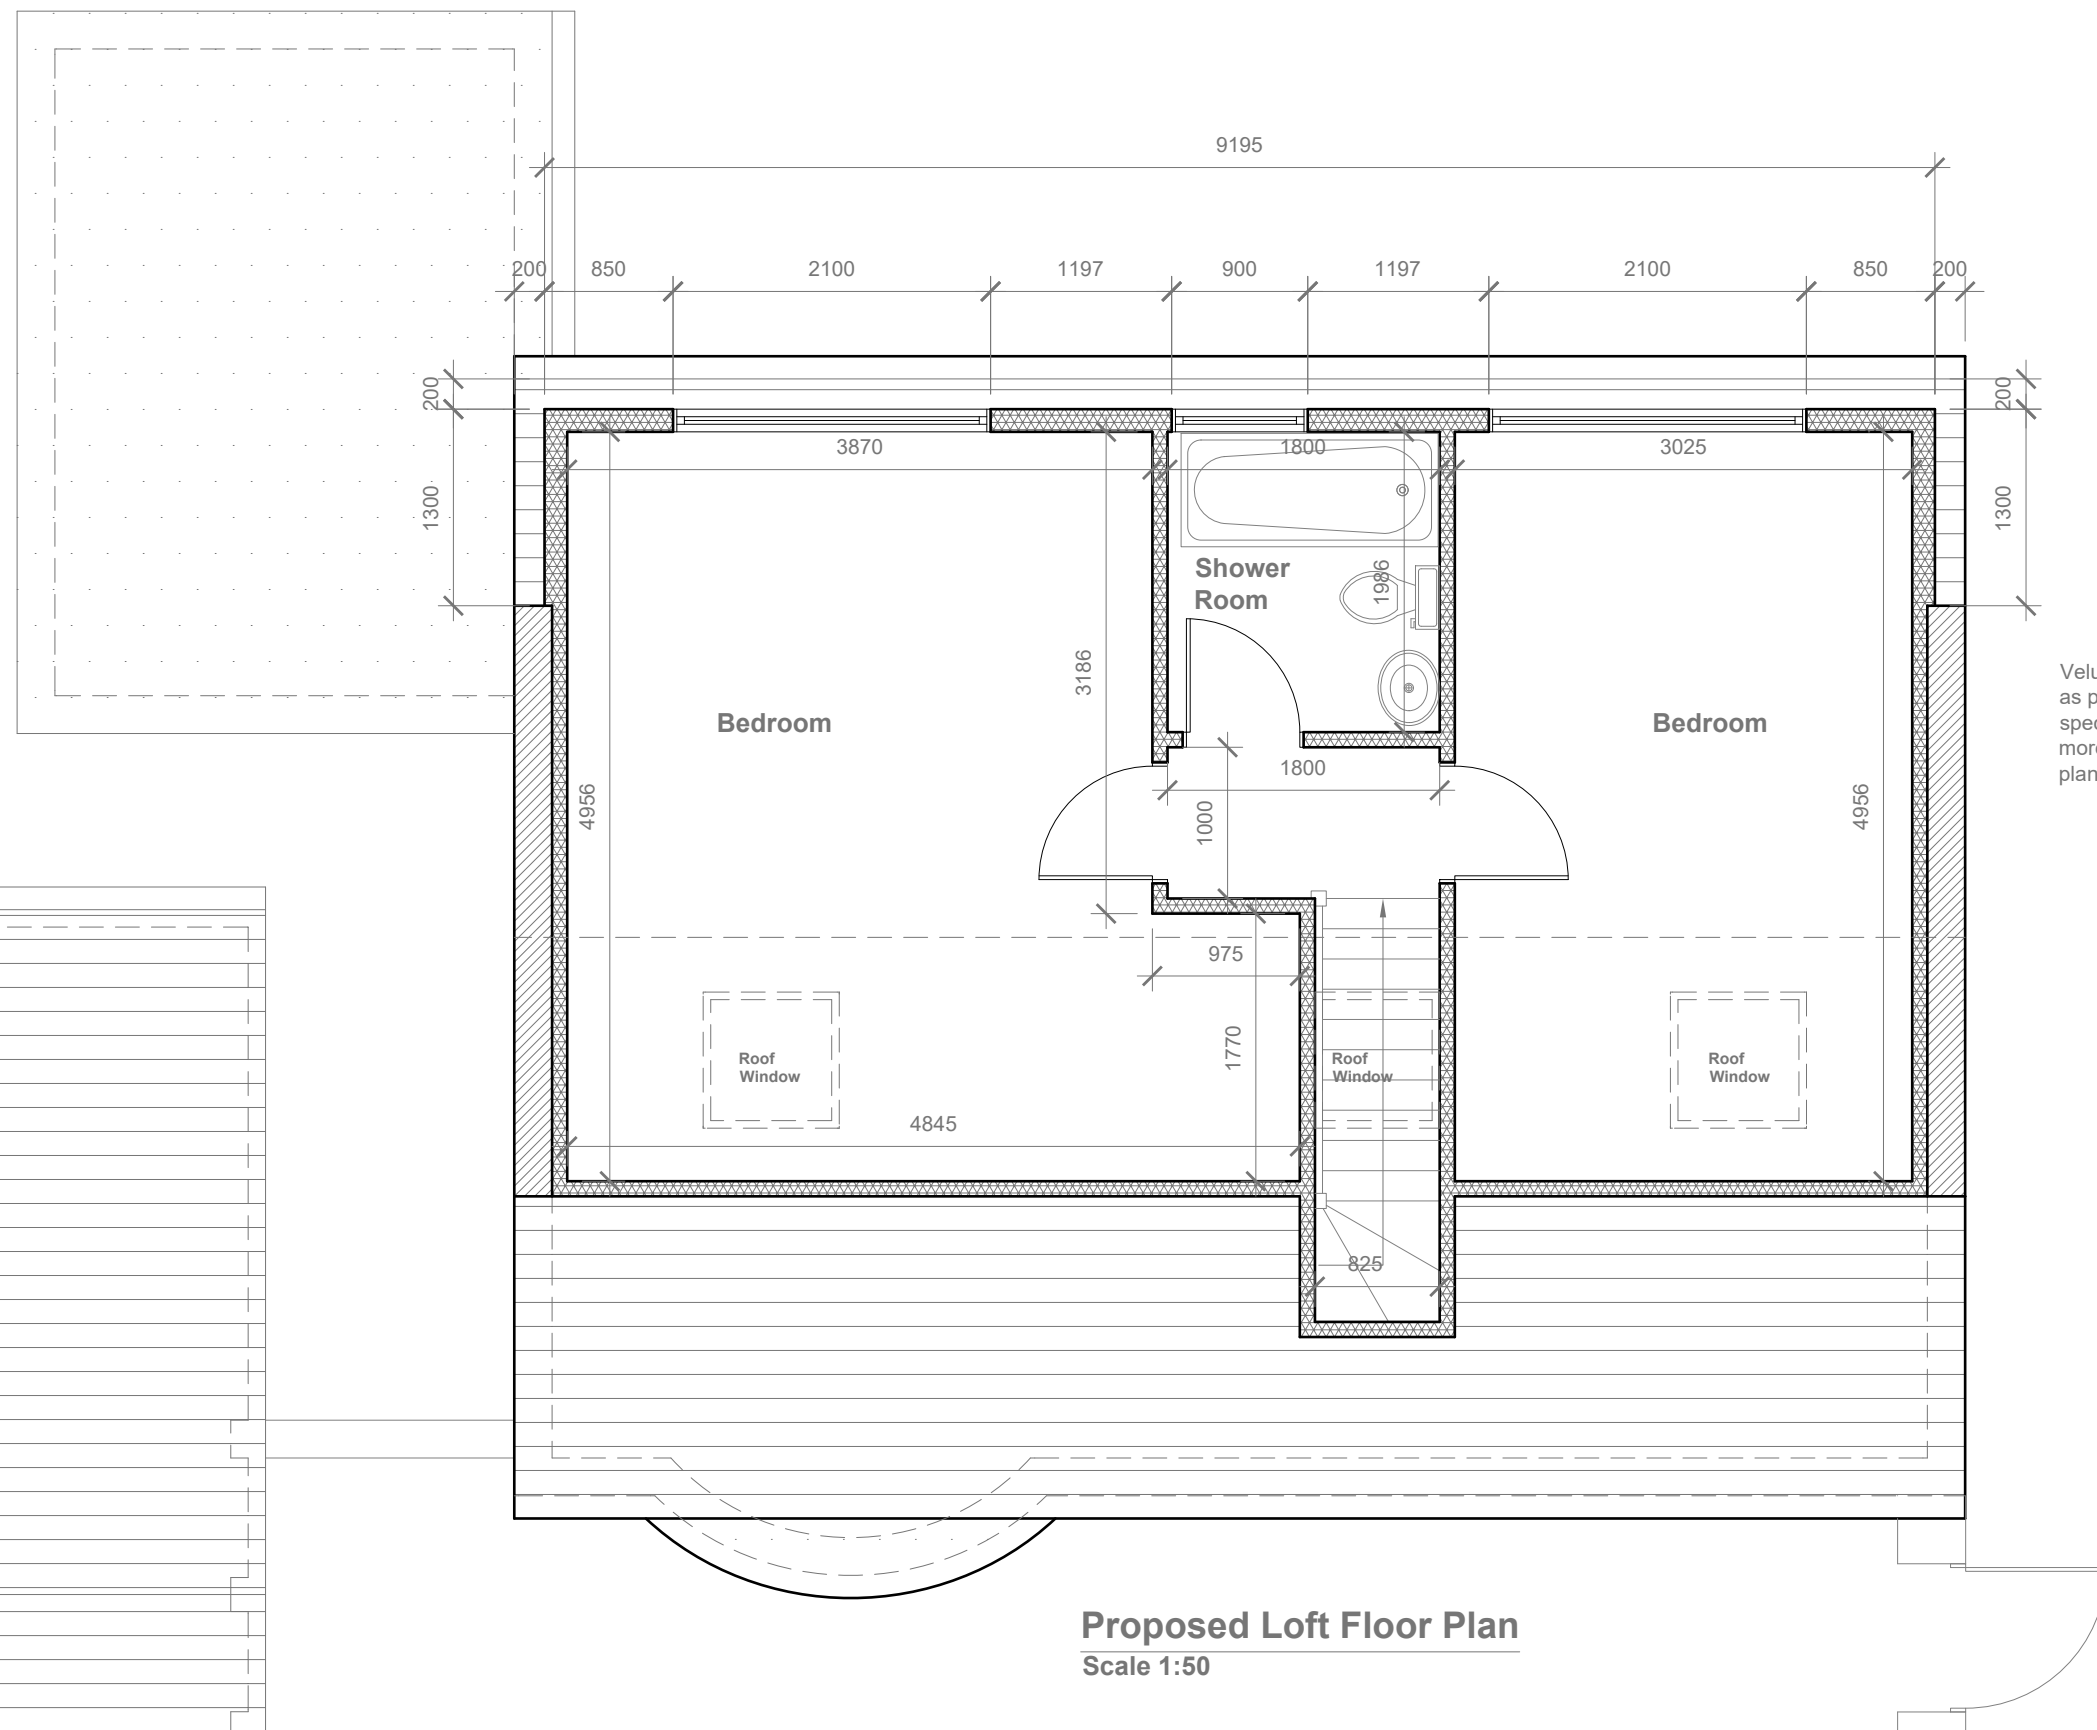
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Velux Window to be installed
as per manufacturer
specification, not projected
more than 150mm from the
plane of roof slope



Proposed Loft Floor Plan
Scale 1:50

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Title:
Proposed Loft Floor Plan

Site Address
29 Green Lane,
Uxbridge.
UB8 3ED

Scale: 1:50 @A3
Date: 14/02/2025
Drawing No.: 2025/021 -04PD
Drawn By: FP

Revision Date:
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