

Proposed Ground Floor Plan

Scale 1:100

VOLUME (HIP TO GABLE ROOF)

$$= (W2 \times H2 \times L3 / 6)$$

$$= (6.454 \times 2.725 \times 3.057 / 6)$$

$$= 8.96 \text{ CU.MT.}$$

VOLUME (2 x DORMERS)

$$= (W1 \times H1 \times L1)$$

$$= (3.904 \times 2.256 \times 2.977)$$

$$= 26.21 \text{ CU.MT.}$$

VOLUME (FF ROOF)
1ST PART

$$= (W3 \times H3 \times L3) / 2$$

$$= (3.831 \times 1.678 \times 2.118) / 2$$

$$= 6.8 \text{ CU.MT.}$$

2ND PART

$$= (W3 \times H3 \times L3) / 2$$

$$= (3.831 \times 1.678 \times 1.915) / 3$$

$$= 4.1 \text{ CU.MT.}$$

$$= 6.8 \text{ CU.MT.} + 4.1 \text{ CU.MT.}$$

$$= 10.9 \text{ CU.MT.}$$

TOTAL VOLUME


$$= 8.96 + 26.21 + 10.9$$

$$= 46.07 \text{ CU.MT.} < 50.00 \text{ CU.MT.}$$



Proposed Front Elevation
Scale 1:100


Proposed External Finish
Materials to Match Existing
External Finish Materials.

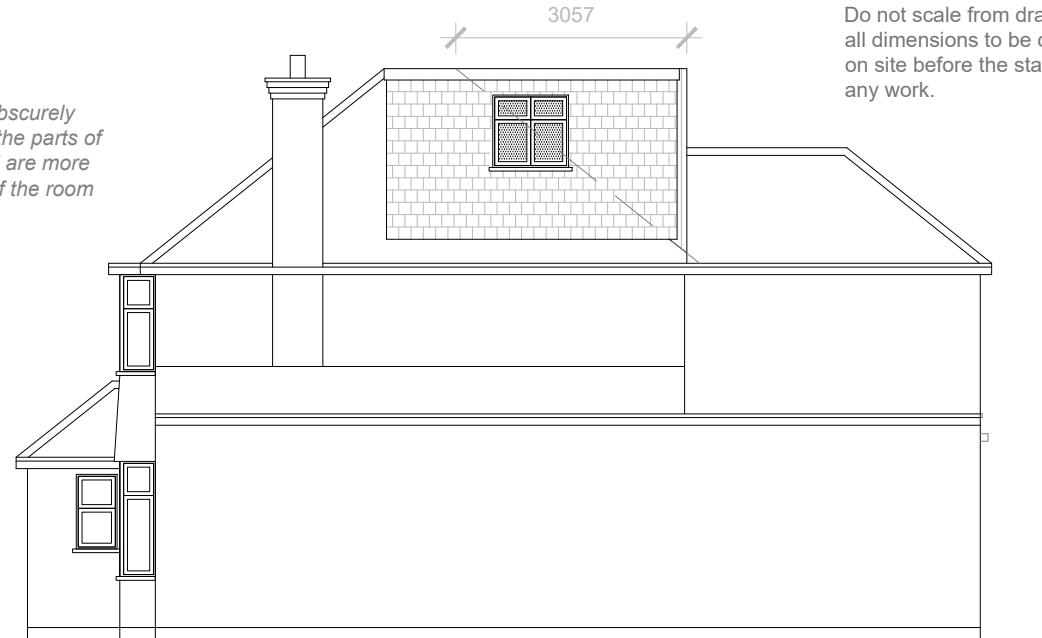

Proposed Side Elevation
Scale 1:100



Proposed Rear Elevation
Scale 1:100

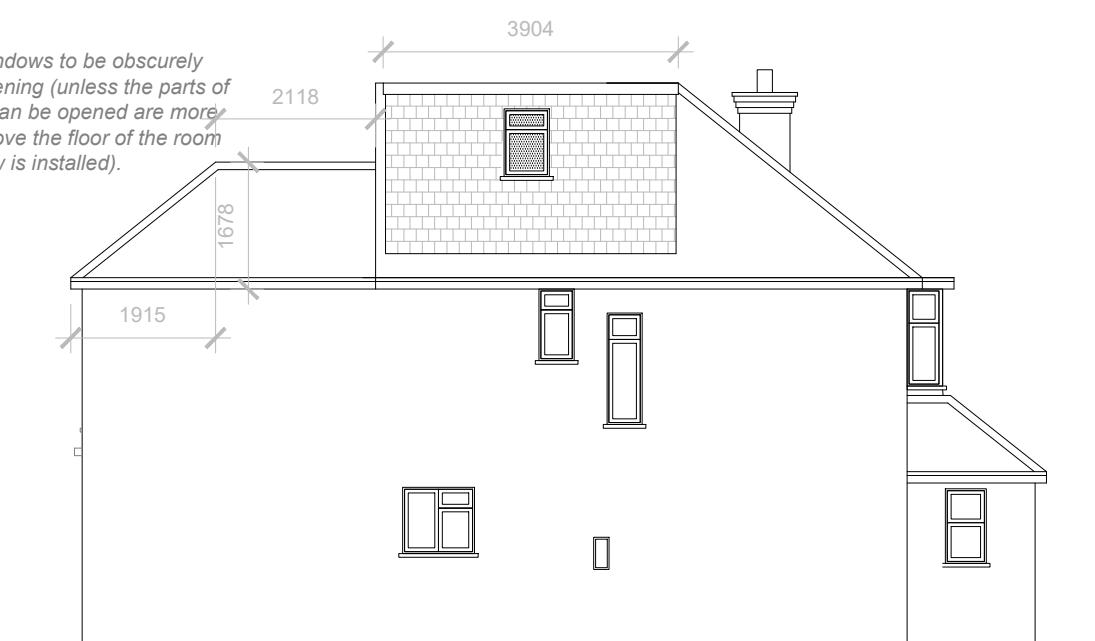

Proposed Side Elevation
Scale 1:100

1:100 0 1 2 5 10 Meter

	Project: 8 Peel Way, Uxbridge, UB8 3RL	Title: Proposed Ground Floor Plan and Elevations	Scale: 1:100 @ A3
Date: 01. 2025		Date: 01. 2025	
Drawing No.: 3781/LT - 03/JG		Drawing No.: 3781/LT - 03/JG	
Revision A		Revision A	
		02.25	

239 Western Road, Southall, Middx, UB2 5HS Tel: 020 8571 1369 info@multicreation.co.uk

All work to comply with
current building regulations
and codes of practice.

Do not scale from drawings
all dimensions to be checked
on site before the start of
any work.