

**V - Design**

Website: V-Design CAD Services Ltd  
Email Address: info@vdesigncad.co.uk

**IMPORTANT NOTES:**

Dimensions to be verified on site  
DO NOT SCALE FROM THIS DRAWING.  
Any areas indicated on this drawing are for guidance only.  
No responsibility is taken for their accuracy.

This drawing is the property of **V-DESIGN CAD Services Ltd**  
Copyright is reserved by them and the drawing is issued on the condition that it is not copied, reproduced, retained or disclosed to any unauthorized person, either wholly or in part without the consent in writing of **V-DESIGN CAD Services Ltd**

Email: vishal.p@vdesigncad.co.uk Mobile: 07971083395

**PROJECT:**

1 Station Road,  
London  
UB8 3AA

**LEGENDS:**

<b>EXISTING:</b>	<b>PROPOSED:</b>
Existing Wall	Proposed Wall
Internal Wall	Internal Wall
Site Boundary	Site Boundary
Windows	Windows
Doors	Doors

**Drawing Title:**

Block and Location Plans

Scale: 1:500, 1:1250 Paper Size: A3

**REVISION/ COMMENTS :**

No:	Comments:	Date:

Drawn By: VG

Job Ref: 25094V

Date: July 2025

Drawing No. PL - 01




**Block Plan**

0 5 10 15 20 25  
metres 1:500 scale



**Site Location**

0 10 20 30 40 50  
metres 1:1250 scale

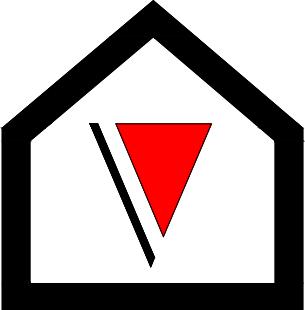

**V - Design**

Company: V-Design CAD Services Ltd  
Website: [www.vdesigncad.co.uk](http://www.vdesigncad.co.uk)  
Email Address: [info@vdesigncad.co.uk](mailto:info@vdesigncad.co.uk)  
Tel : +44 20 3488 4890  
Mobile: +44 7312015617

IMPORTANT NOTES:

Dimensions to be verified on site  
DO NOT SCALE FROM THIS DRAWING.  
Any areas indicated on this drawing are for guidance only.  
No responsibility is taken for their accuracy.

This drawing is the property of **V-DESIGN CAD Services Ltd**. Copyright is reserved by them and the drawing is issued on the condition that it is not copied, reproduced, retained or disclosed to any unauthorized person, either wholly or in part without the consent in writing of **V-DESIGN CAD Services Ltd**.

1 Station Road,  
London  
UB8 3AA

LEGENDS:

EXISTING:	PROPOSED:
Existing Wall	Cavity Wall
Internal Wall	Internal Wall
Site Boundary	Site Boundary
Windows	Windows
Doors	Doors


Drawing Title:  
Existing Shop Floor Plan  
Scale: 1:50 Paper Size: A3


REVISION/ COMMENTS :		
No:	Comments:	Date:

Existing Shop Floor Plan

0 0.5 1.0 1.5 2.0 2.5  
metres 1:50 scale

Drawn By: VG  
Job Ref: 25094V  
Date: July 2025  
Drawing No. PL - 02

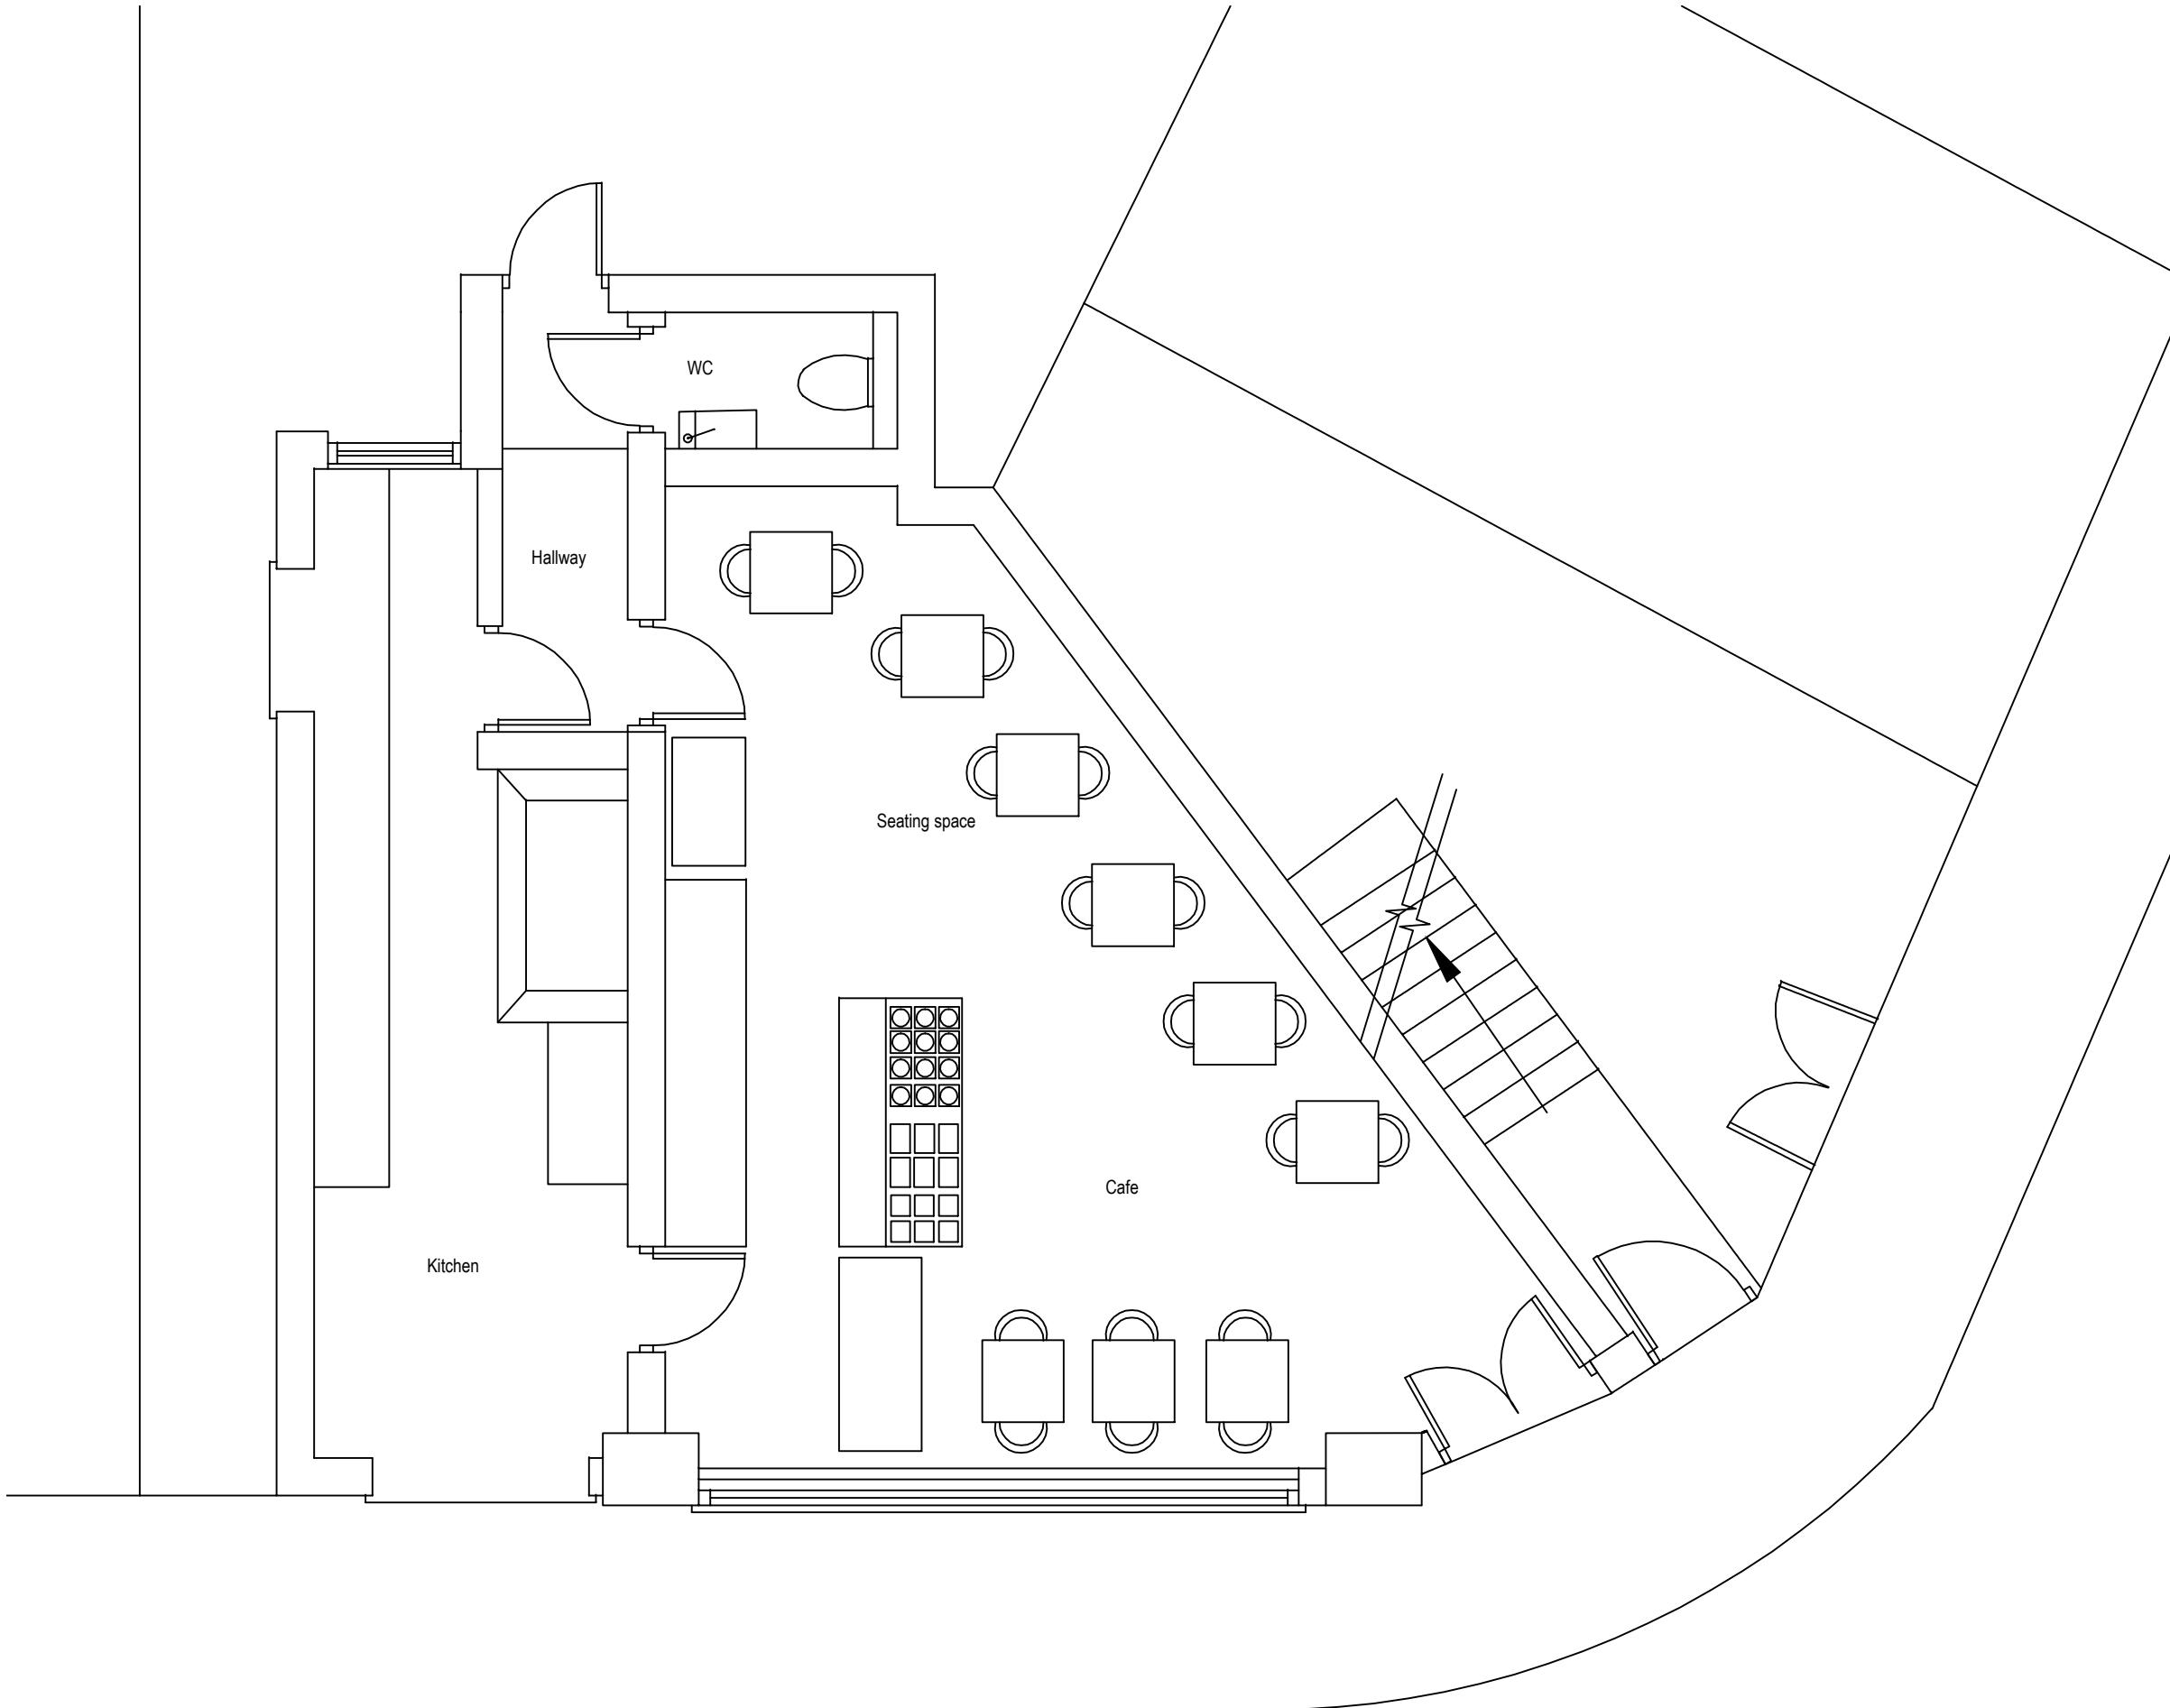

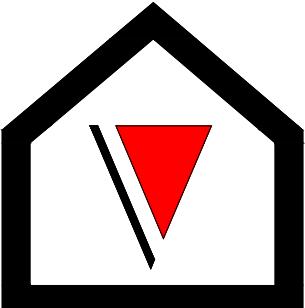


**V - Design**

Company: V-Design CAD Services Ltd  
 Website: [www.vdesigncad.co.uk](http://www.vdesigncad.co.uk)  
 Email Address: [info@vdesigncad.co.uk](mailto:info@vdesigncad.co.uk)  
 Tel : +44 20 3488 4890  
 Mobile: +44 7312015617

IMPORTANT NOTES:

Dimensions to be verified on site  
 DO NOT SCALE FROM THIS DRAWING.  
 Any areas indicated on this drawing are for guidance only.  
 No responsibility is taken for their accuracy.

This drawing is the property of **V-DESIGN CAD Services Ltd**. Copyright is reserved by them and the drawing is issued on the condition that it is not copied, reproduced, retained or disclosed to any unauthorized person, either wholly or in part without the consent in writing of **V-DESIGN CAD Services Ltd**.

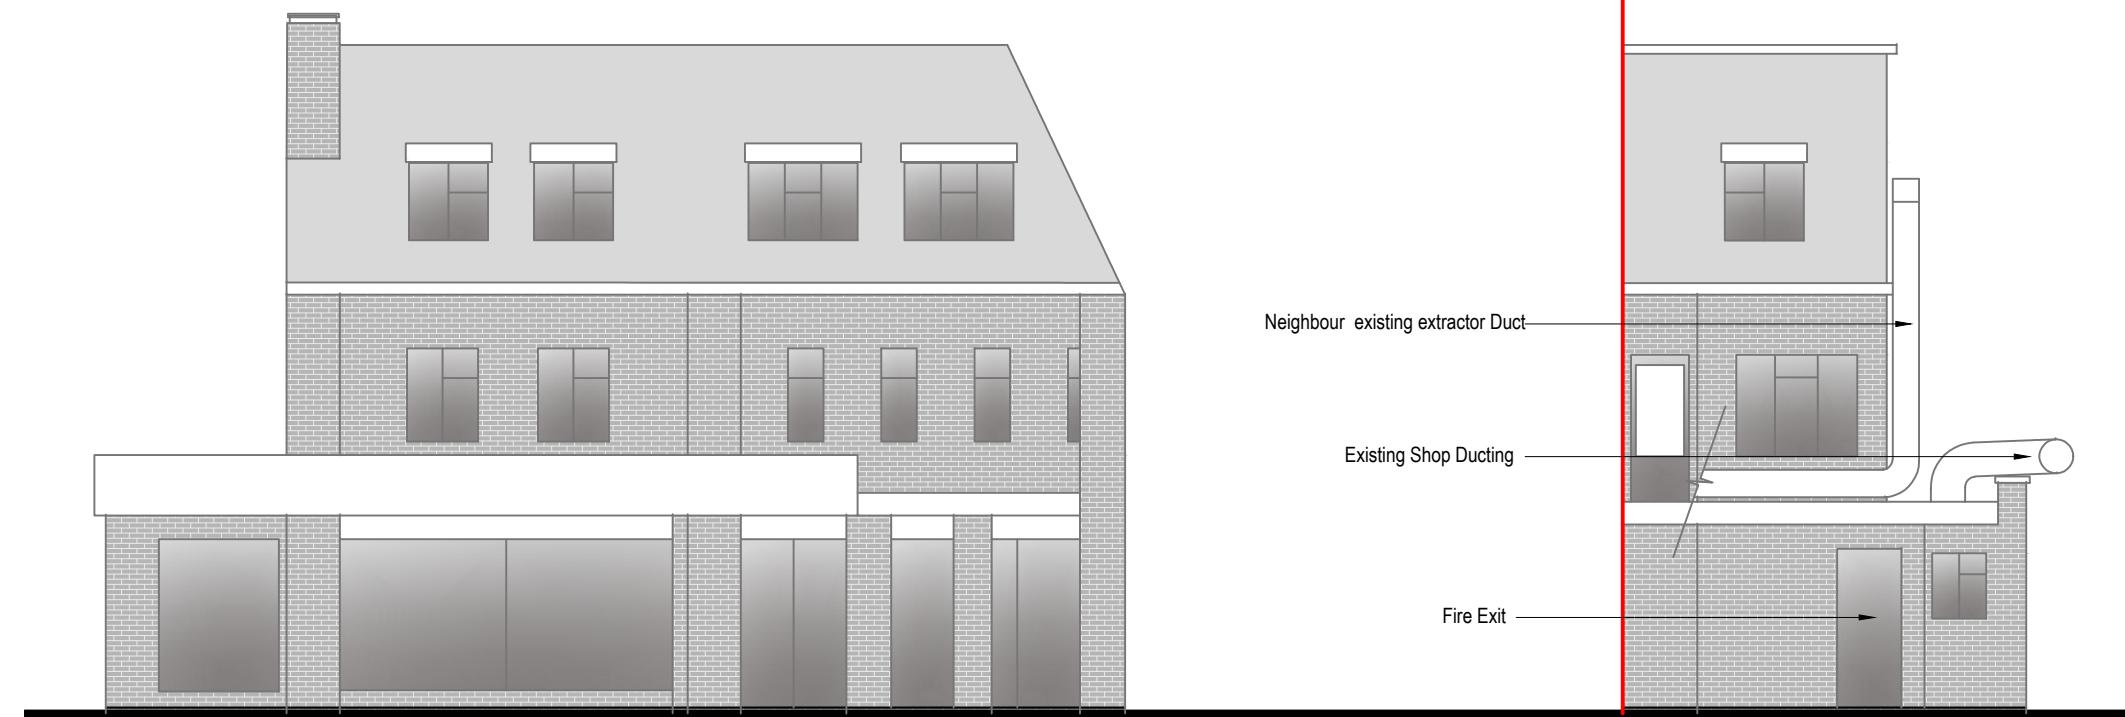


Front Elevation

0 1 2 3 4 5  
 metres 1:100 scale

Rear Elevation

0 1 2 3 4 5  
 metres 1:100 scale

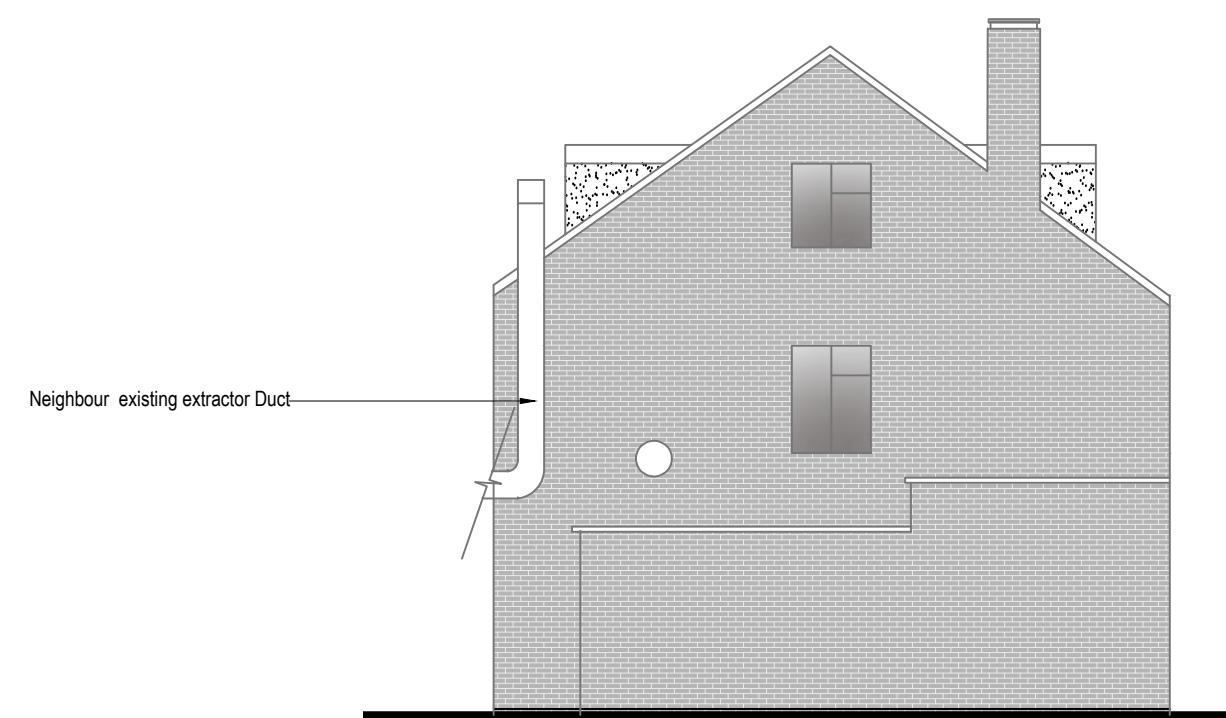

Side Elevation

0 1 2 3 4 5  
 metres 1:100 scale

1 Station Road,  
 London  
 UB8 3AA


LEGENDS:

EXISTING:	PROPOSED:
Existing Wall	Cavity Wall
Internal Wall	Internal Wall
Site Boundary	Site Boundary
Windows	Windows
Doors	Doors

Drawing Title:	
Existing Elevations	
Scale: 1:100	Paper Size: A3

REVISION/ COMMENTS :		
No:	Comments:	Date:

Drawn By: VG  
 Job Ref: 25094V  
 Date: July 2025  
 Drawing No. PL - 03

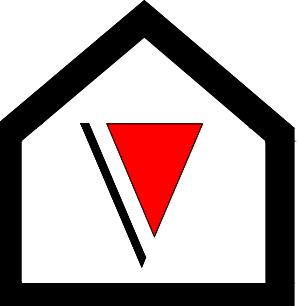


**V - Design**

Company: V-Design CAD Services Ltd  
Website: [www.vdesigncad.co.uk](http://www.vdesigncad.co.uk)  
Email Address: [info@vdesigncad.co.uk](mailto:info@vdesigncad.co.uk)  
Tel : +44 20 3488 4890  
Mobile: +44 7312015617

IMPORTANT NOTES:

Dimensions to be verified on site  
DO NOT SCALE FROM THIS DRAWING.  
Any areas indicated on this drawing are for guidance only.  
No responsibility is taken for their accuracy.

This drawing is the property of **V-DESIGN CAD Services Ltd**. Copyright is reserved by them and the drawing is issued on the condition that it is not copied, reproduced, retained or disclosed to any unauthorized person, either wholly or in part without the consent in writing of **V-DESIGN CAD Services Ltd**.

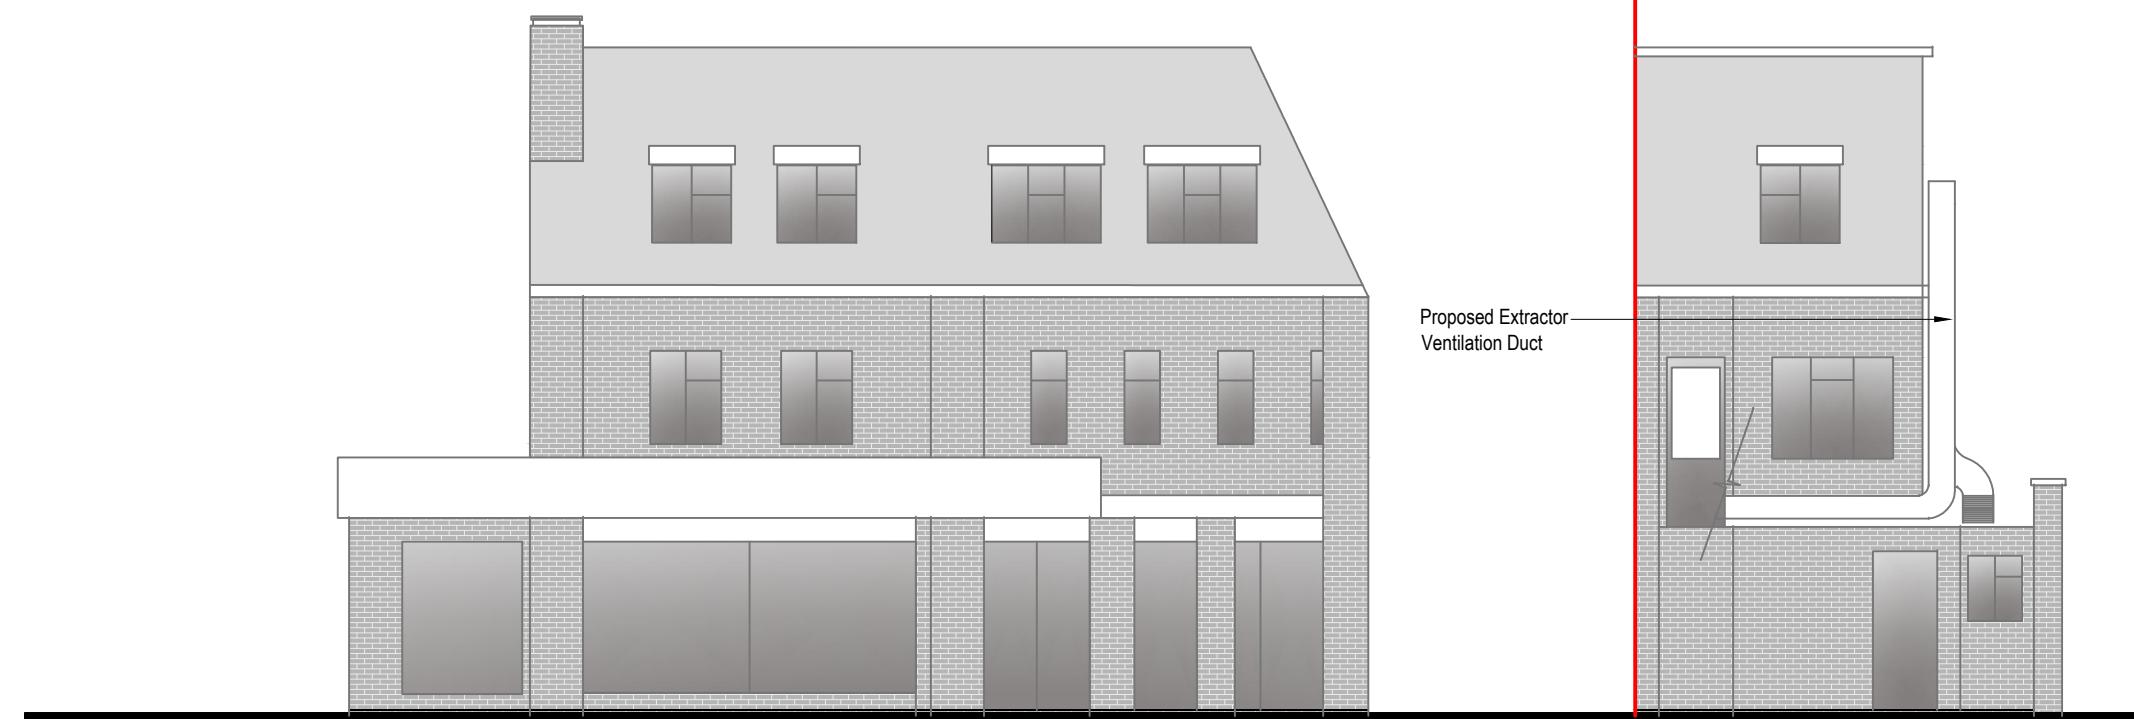


Front Elevation

0 1 2 3 4 5  
metres 1:100 scale

Rear Elevation

0 1 2 3 4 5  
metres 1:100 scale

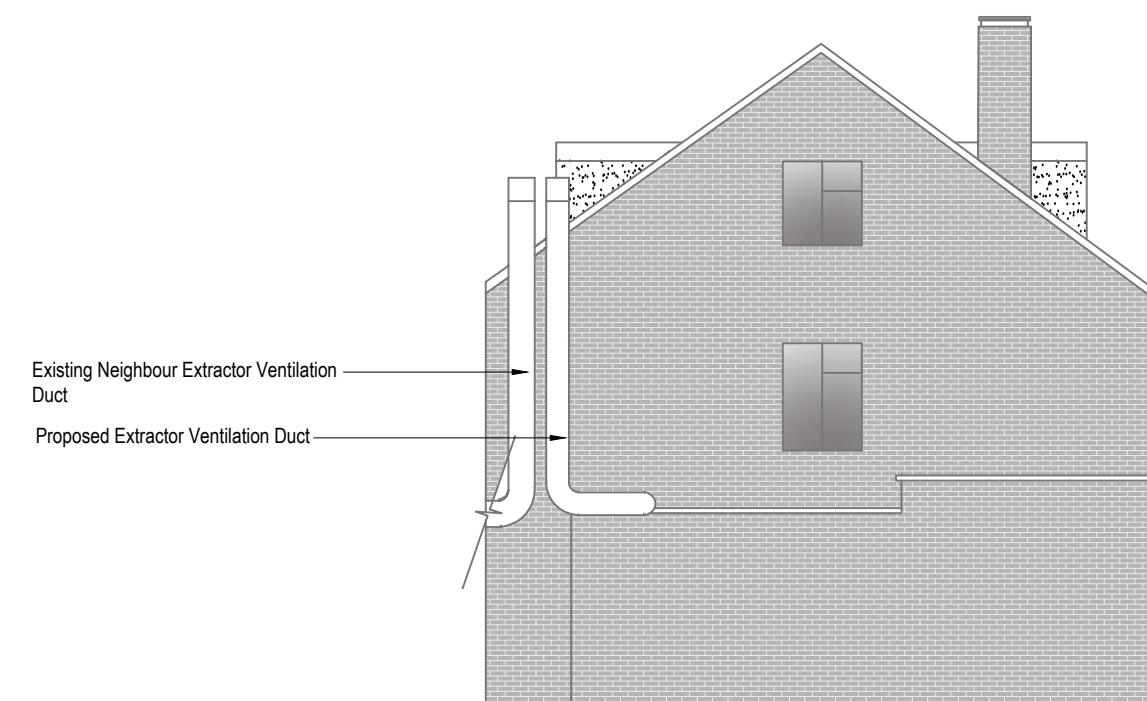

Side Elevation

0 1 2 3 4 5  
metres 1:100 scale

LEGENDS:

EXISTING:	PROPOSED:
Existing Wall	Cavity Wall
Internal Wall	Internal Wall
Site Boundary	Site Boundary
Windows	Windows
Doors	Doors

Drawing Title:	
Proposed Elevations	
Scale: 1:100	Paper Size: A3

REVISION/ COMMENTS :		
No:	Comments:	Date:

Drawn By:	VG
Job Ref:	25094V
Date:	July 2025
Drawing No.	PL - 04