

## GENERAL NOTES

All dimensions, levels, sizes, positions and locations of particulars as indicated on drawings are to be verified by the appointed Contractor on site prior to engaging in works. Any discrepancies must be reported to the Architect/Surveyor/Engineer or responsible person/s immediately.

No dimension to be scaled from the drawings for construction purposes unless otherwise indicated. All work is to comply with current Building Regulations.

Party Wall etc. Act 1996 would apply and contractor is to assure that no work is commenced until this formality is completed.

The sole purpose of this drawing is the procurement of Planning Permission and Building Regulation approval and work is NOT to commence before such approvals.

Where this drawing is used for the works, contractor should request at the time of tender, from the tenderer, full specification and schedule of work. To avoid any disputes, this schedule of works in conjunction with the drawings would be used to resolve matters.

Contractor to assure and satisfy himself that necessary Planning permission and Building Regulations are approved before tendering or commencement of works.


The competent person is to send to the local authority via the scheme provider a self-certification certificate within 30 days of the electrical works' completion. The client must receive both a copy of the self certificate and a BS7671 Electrical Installation Test Certificate. (Reg. P1)

The Gas and Boiler installations will be carried out by a suitably qualified CORGI registered gas engineer or equal approved.


The Contractor is responsible for ensuring compliance with the CDM Regulations, and appropriate Health & Safety on site precautions.

0 1m 2m 3m 4m 5m  
Scale 1:100  
0 1m 2m  
Scale 1:50

REVISION	DESCRIPTION	BY	DATE
	SHAH DESIGNS LTD		
+44 07985 433 242 15 Derwent Avenue, Pinner, Harrow, HA5 4QH darshikas@shahdesignsltd.co.uk www.shahdesignsltd.co.uk			
PROJECT			
74 THE CHASE PINNER HA5 1SN			
DRAWING TITLE			
EXISTING FLOOR PLANS AND ELEVATIONS			
DATE	19.05.2023	DRAWN BY	SD
SCALE	1:50 @ A1	CHECKED BY	SD
DRAWING NO.	SD225(B)01		
REVISION			

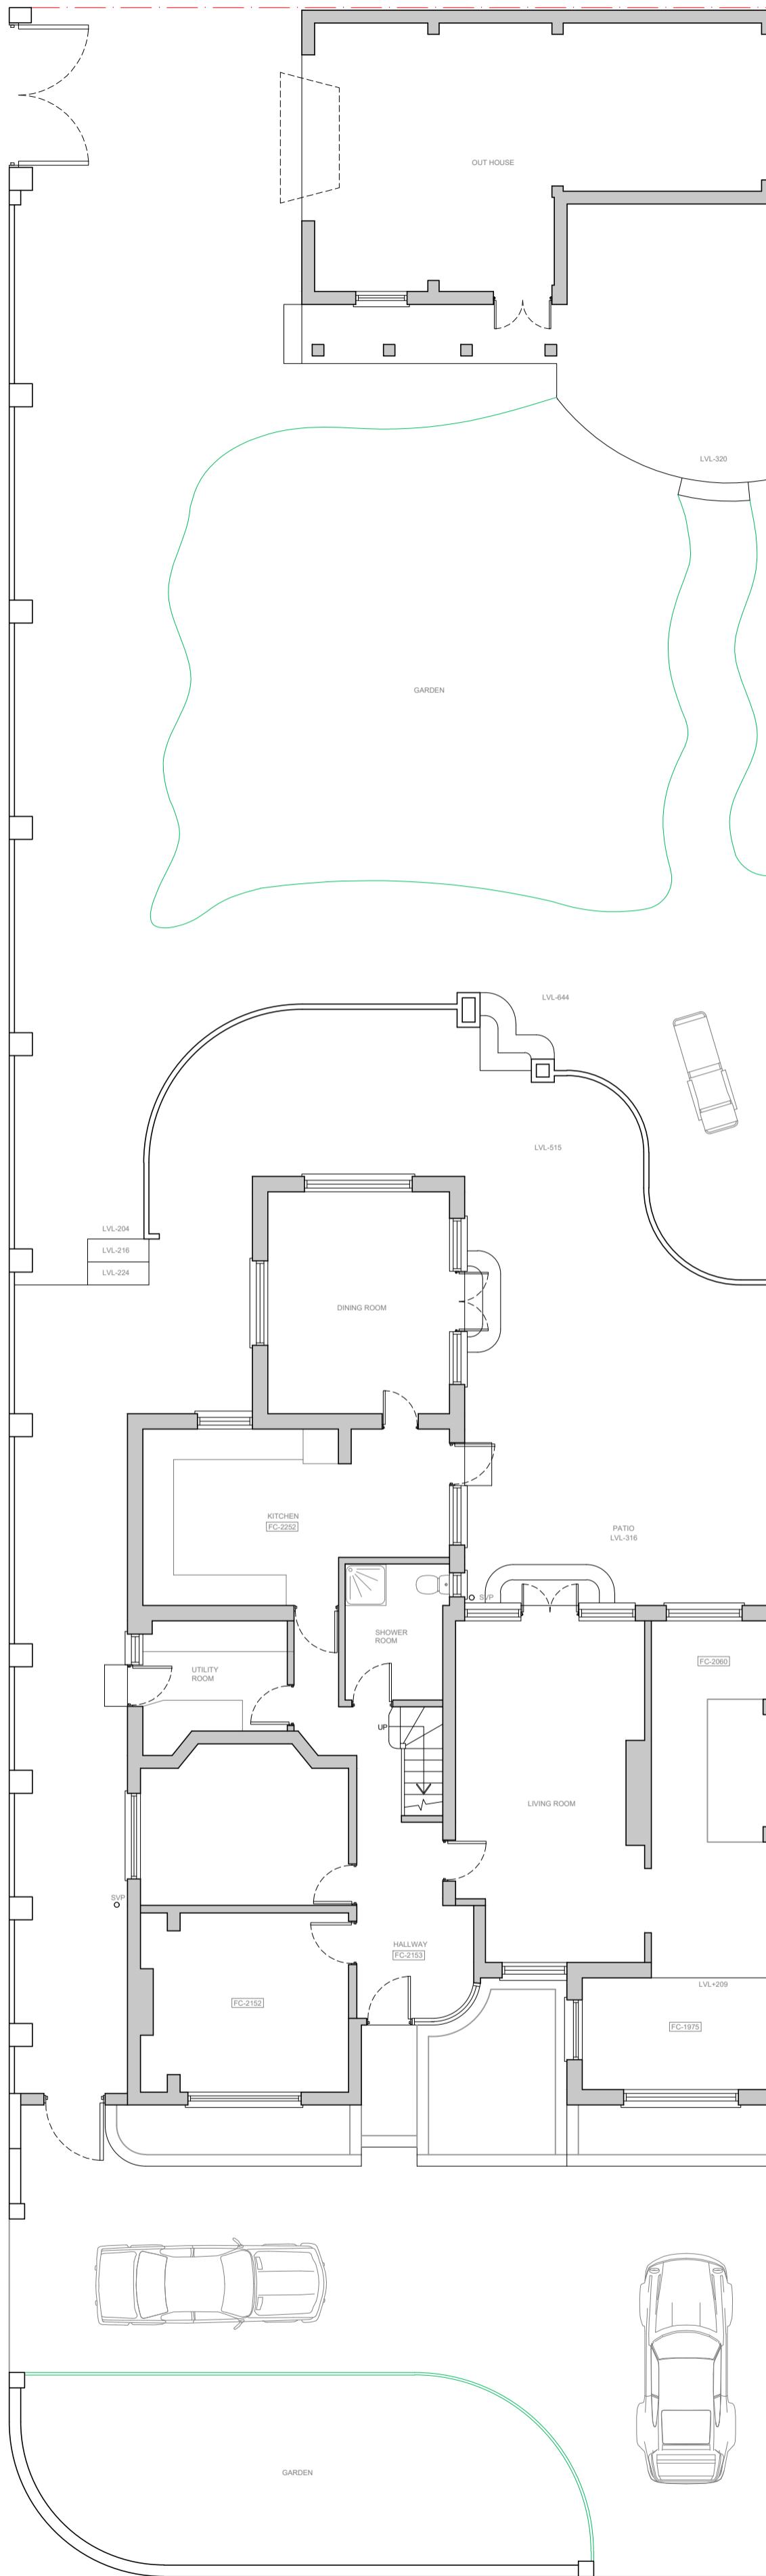

EXISTING GROUND FLOOR PLAN  
SCALE 1:100

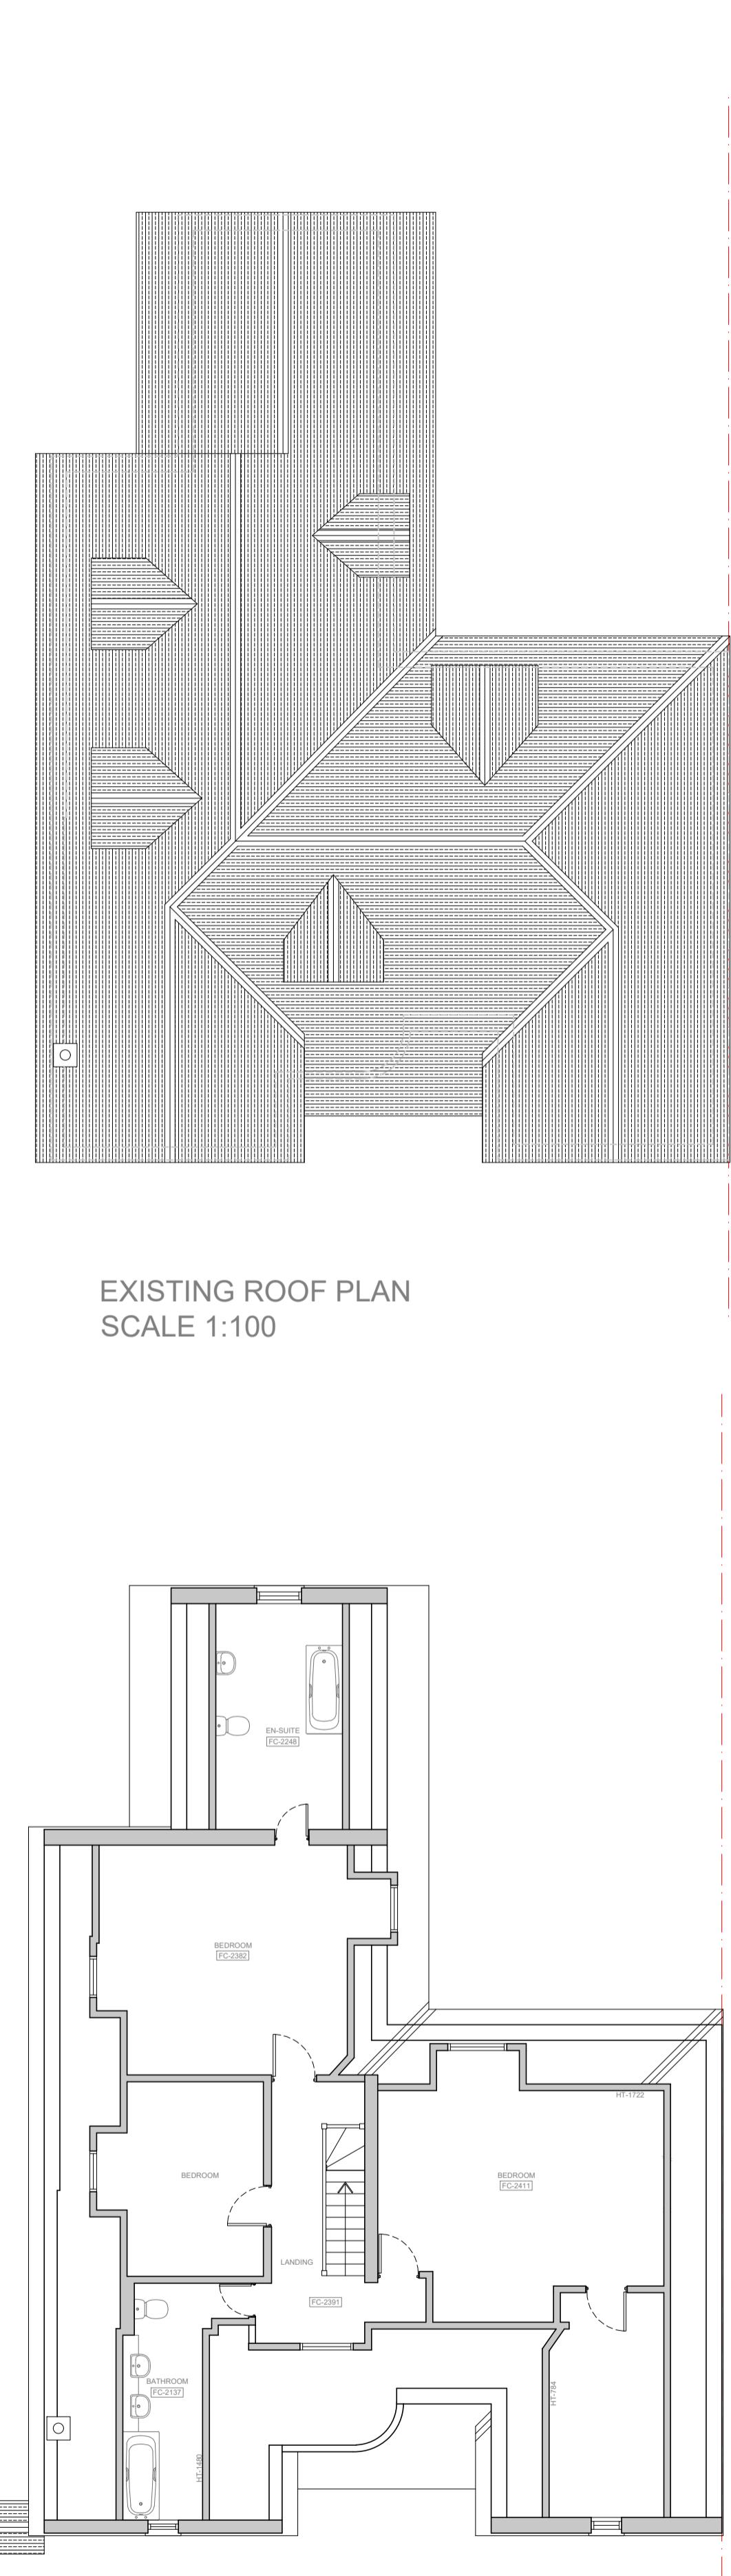

EXISTING FIRST FLOOR PLAN  
SCALE 1:100



EXISTING FRONT ELEVATION  
SCALE 1:100



EXISTING SIDE ELEVATION  
SCALE 1:100



EXISTING REAR ELEVATION  
SCALE 1:100



EXISTING SIDE ELEVATION (VIEW FROM THE ROAD)  
SCALE 1:100