



EXISTING DWELLING
SIDE ELEVATION




EXISTING DWELLING
REAR ELEVATION

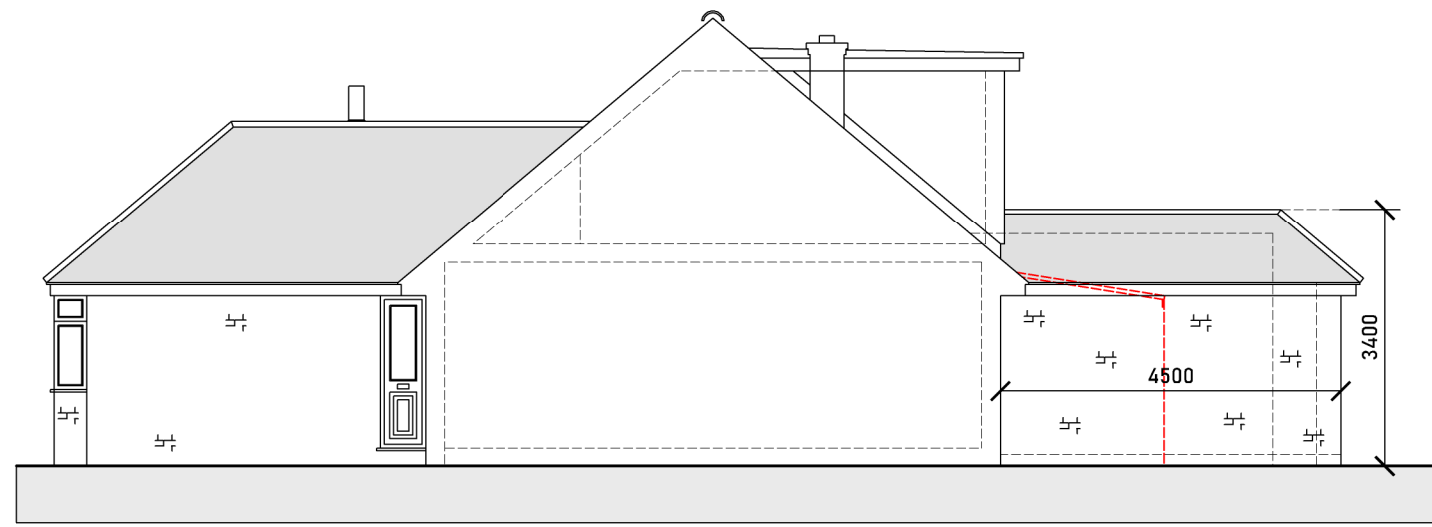

PROPOSED DWELLING
SIDE ELEVATION

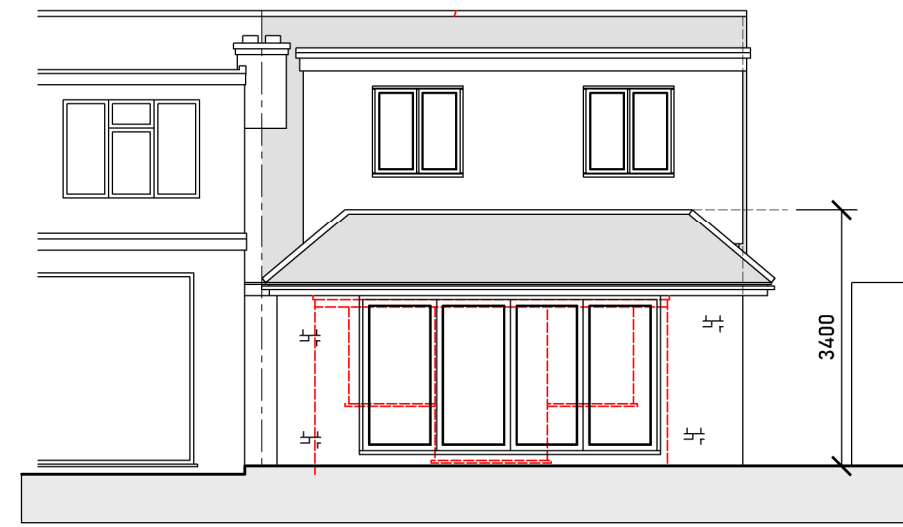


PROPOSED DWELLING
REAR ELEVATION

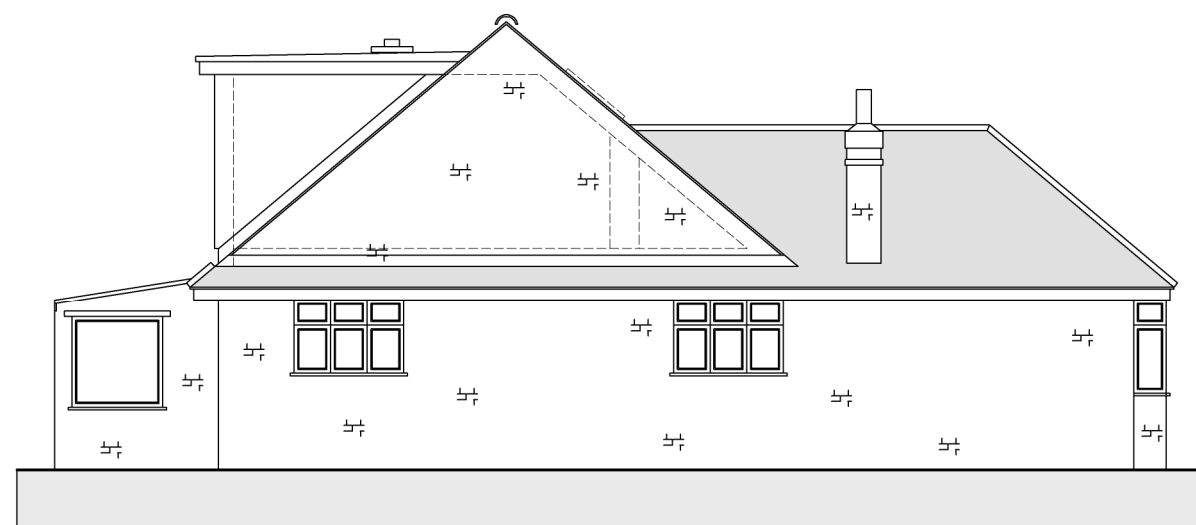

EXISTING DWELLING
SIDE ELEVATION





EXISTING DWELLING
FRONT ELEVATION

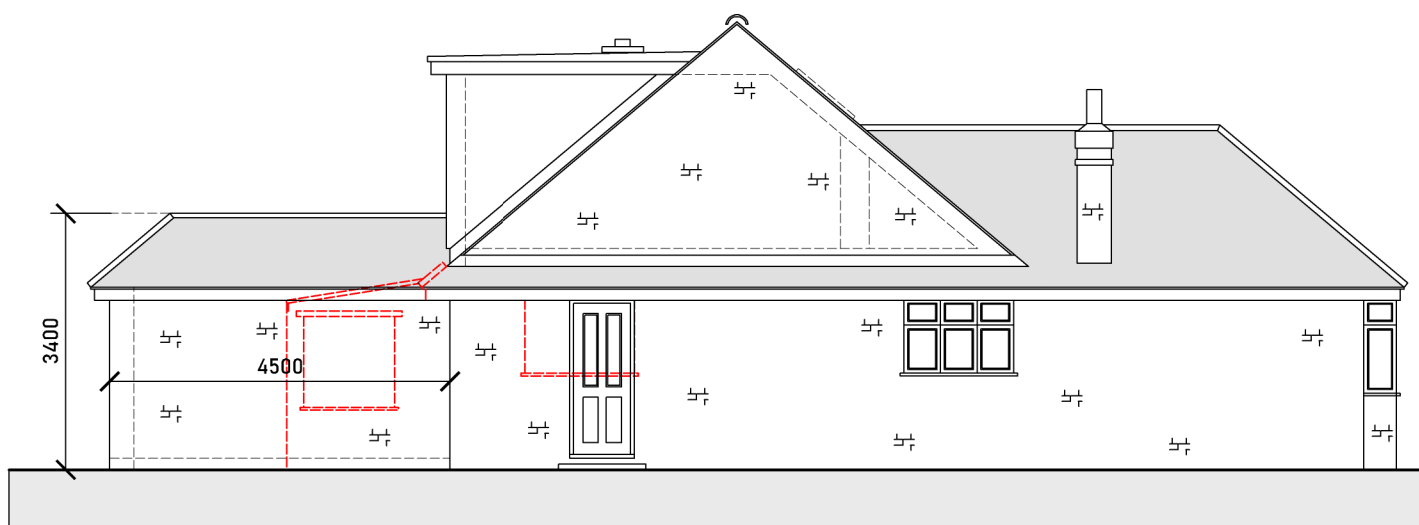


PROPOSED DWELLING
SIDE ELEVATION

SCALE BAR (m)


0 2 4 6 8 10

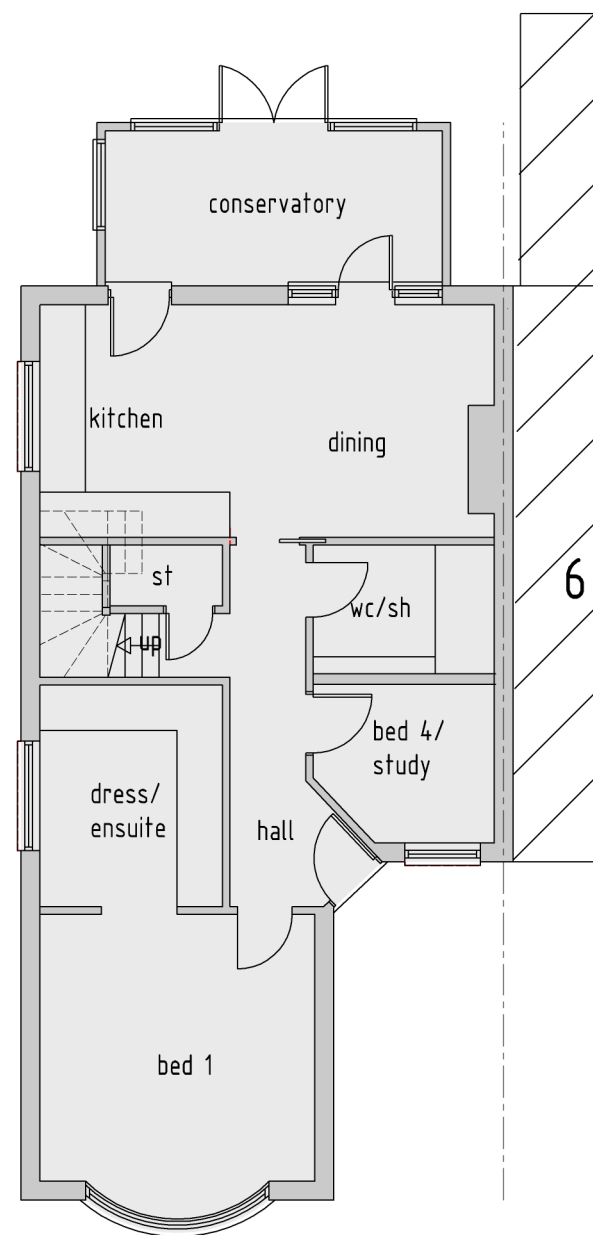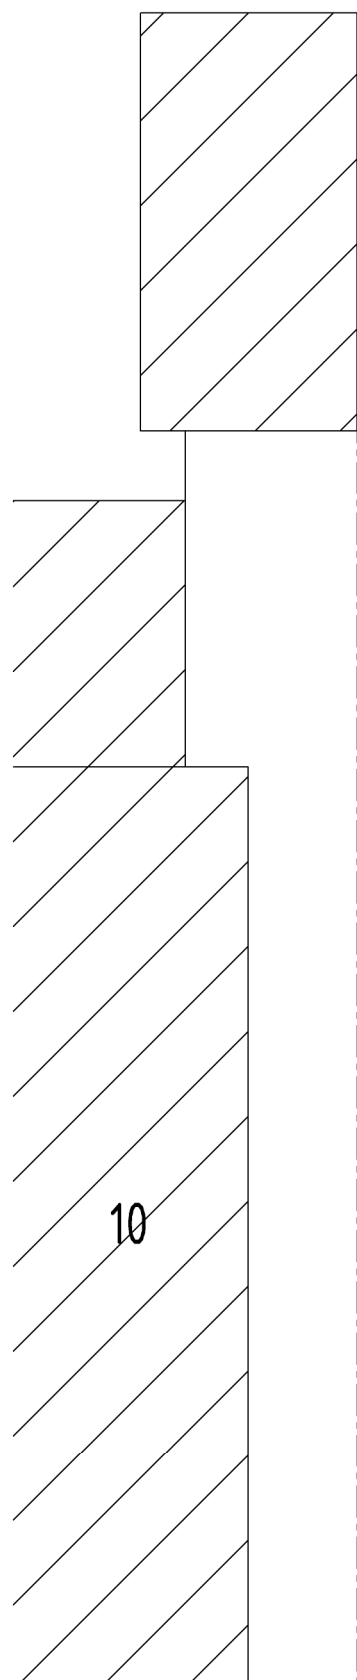


EXISTING DWELLING
GROUND FLOOR PLAN

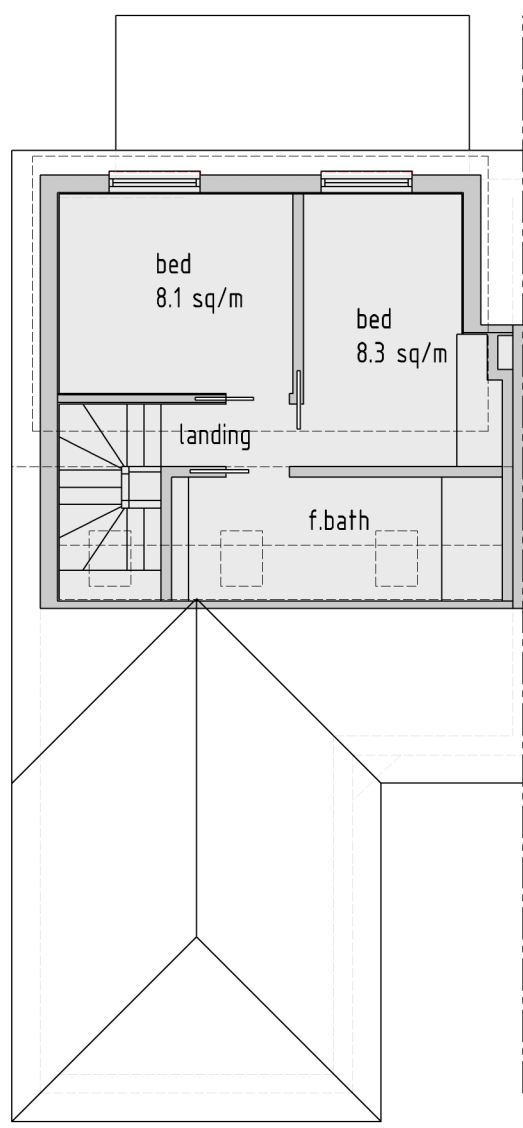

EXISTING DWELLING
ROOF AREA PLAN

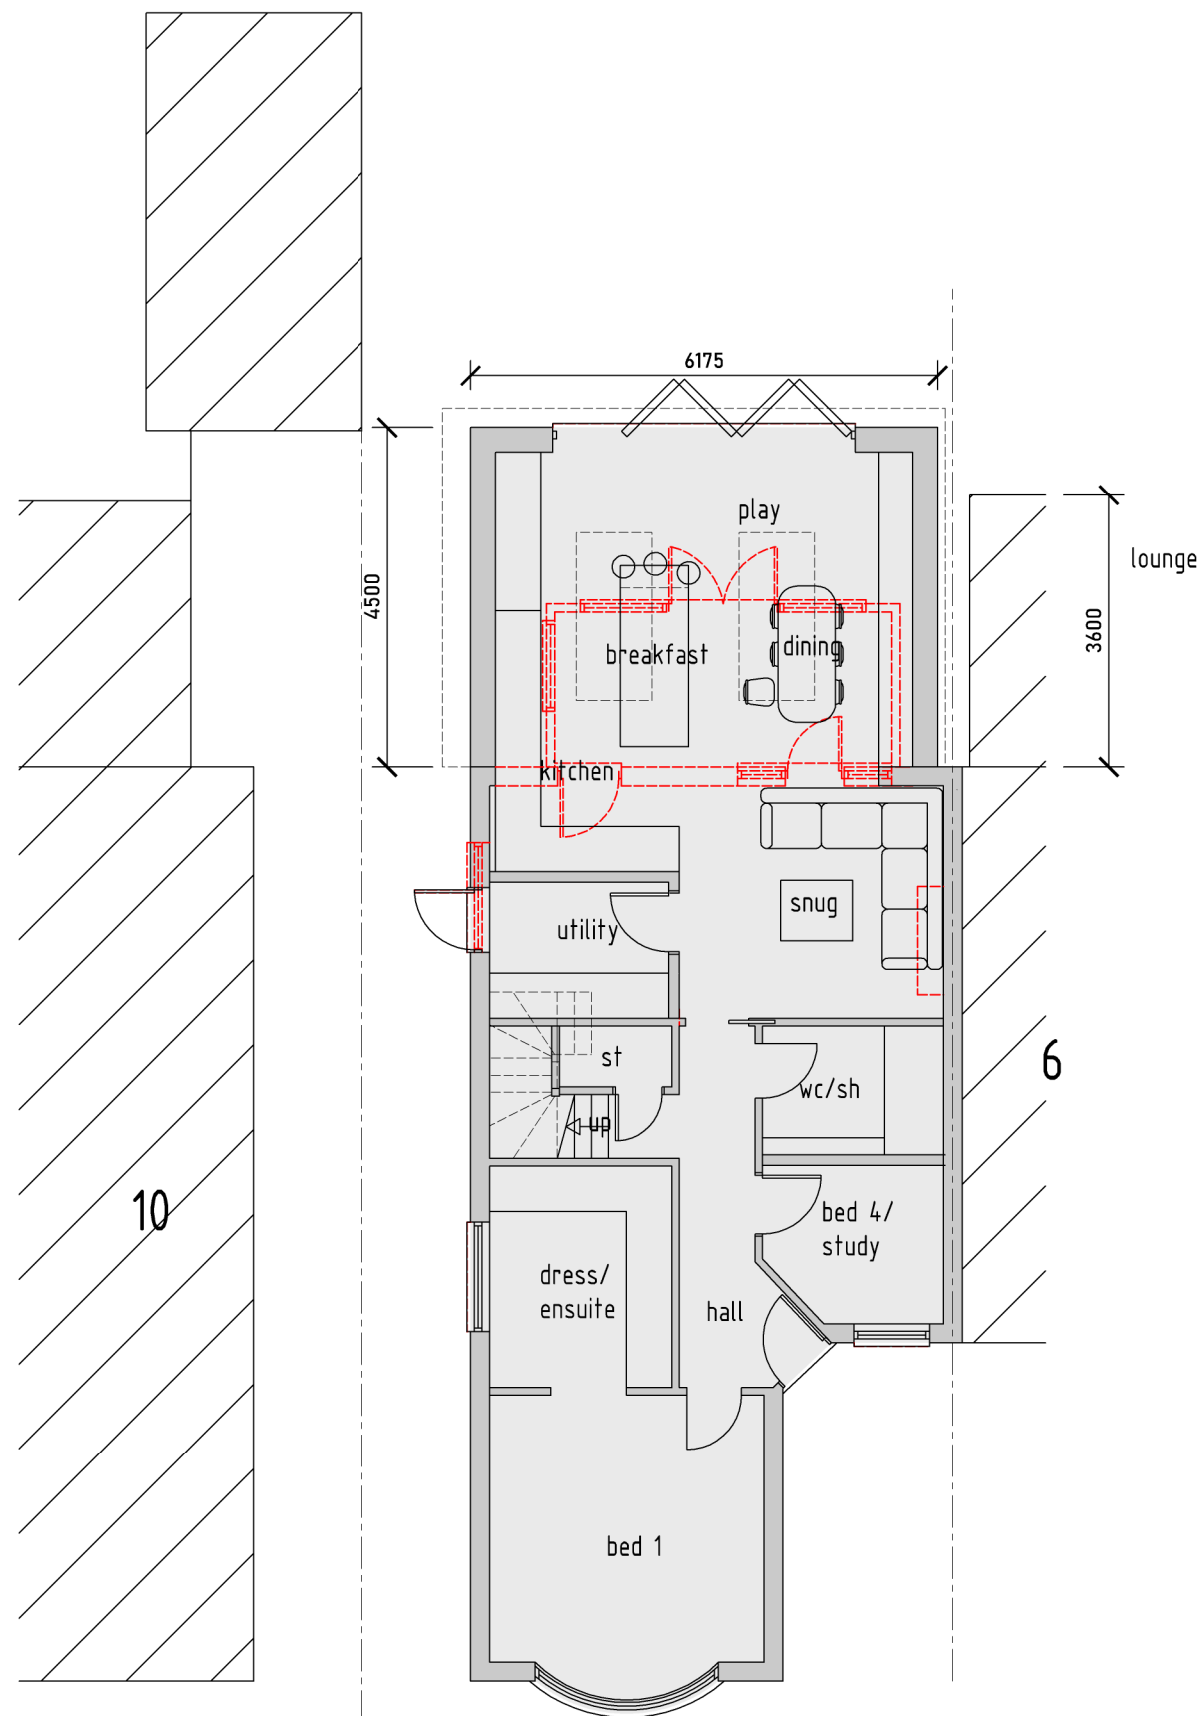


PROPOSED DWELLING
GROUND FLOOR PLAN

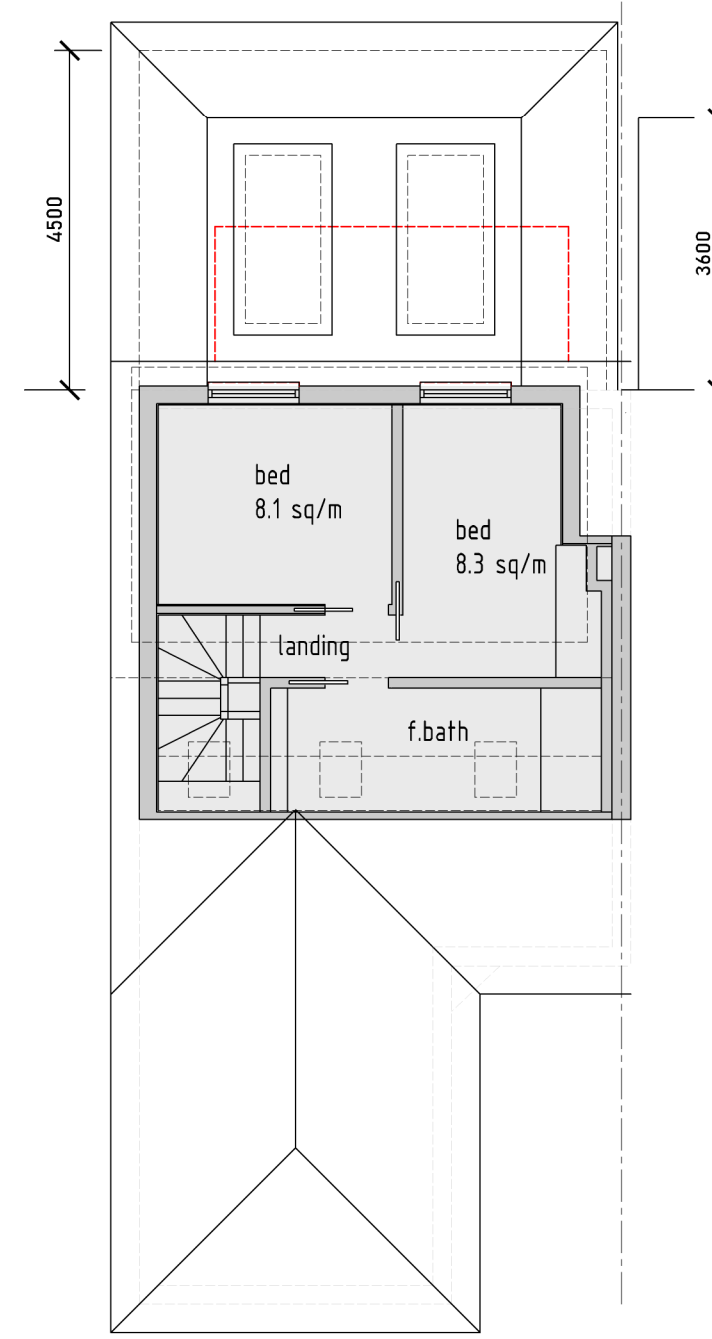

PROPOSED DWELLING
FIRST FLOOR PLAN

- NOTES
1. All dimensions are to be checked on site prior to the commencement of work and any discrepancy is to be reported to the construction manager before construction.
 2. All work is to comply with current Building Regulations and allied legislation.
 3. All contractors and sub-contractors must ensure that they have the latest issue of this drawing and details before the commencement of work on site.
 4. All materials are to be used and installed in strict compliance with the relevant manufacturers instructions and recommendations.
 5. All works on site, managed and implemented as a result of the designs indicated on this drawing, are to be given full consideration for compliance with the Health and Safety CDM Regulations in respect of design and implementation on site and no works are to be undertaken if it is considered that compliance with the Building Regulations cannot be achieved.
 6. All dimensions shown in millimetres.
 7. Footprint of buildings shown at 10m above ground level.

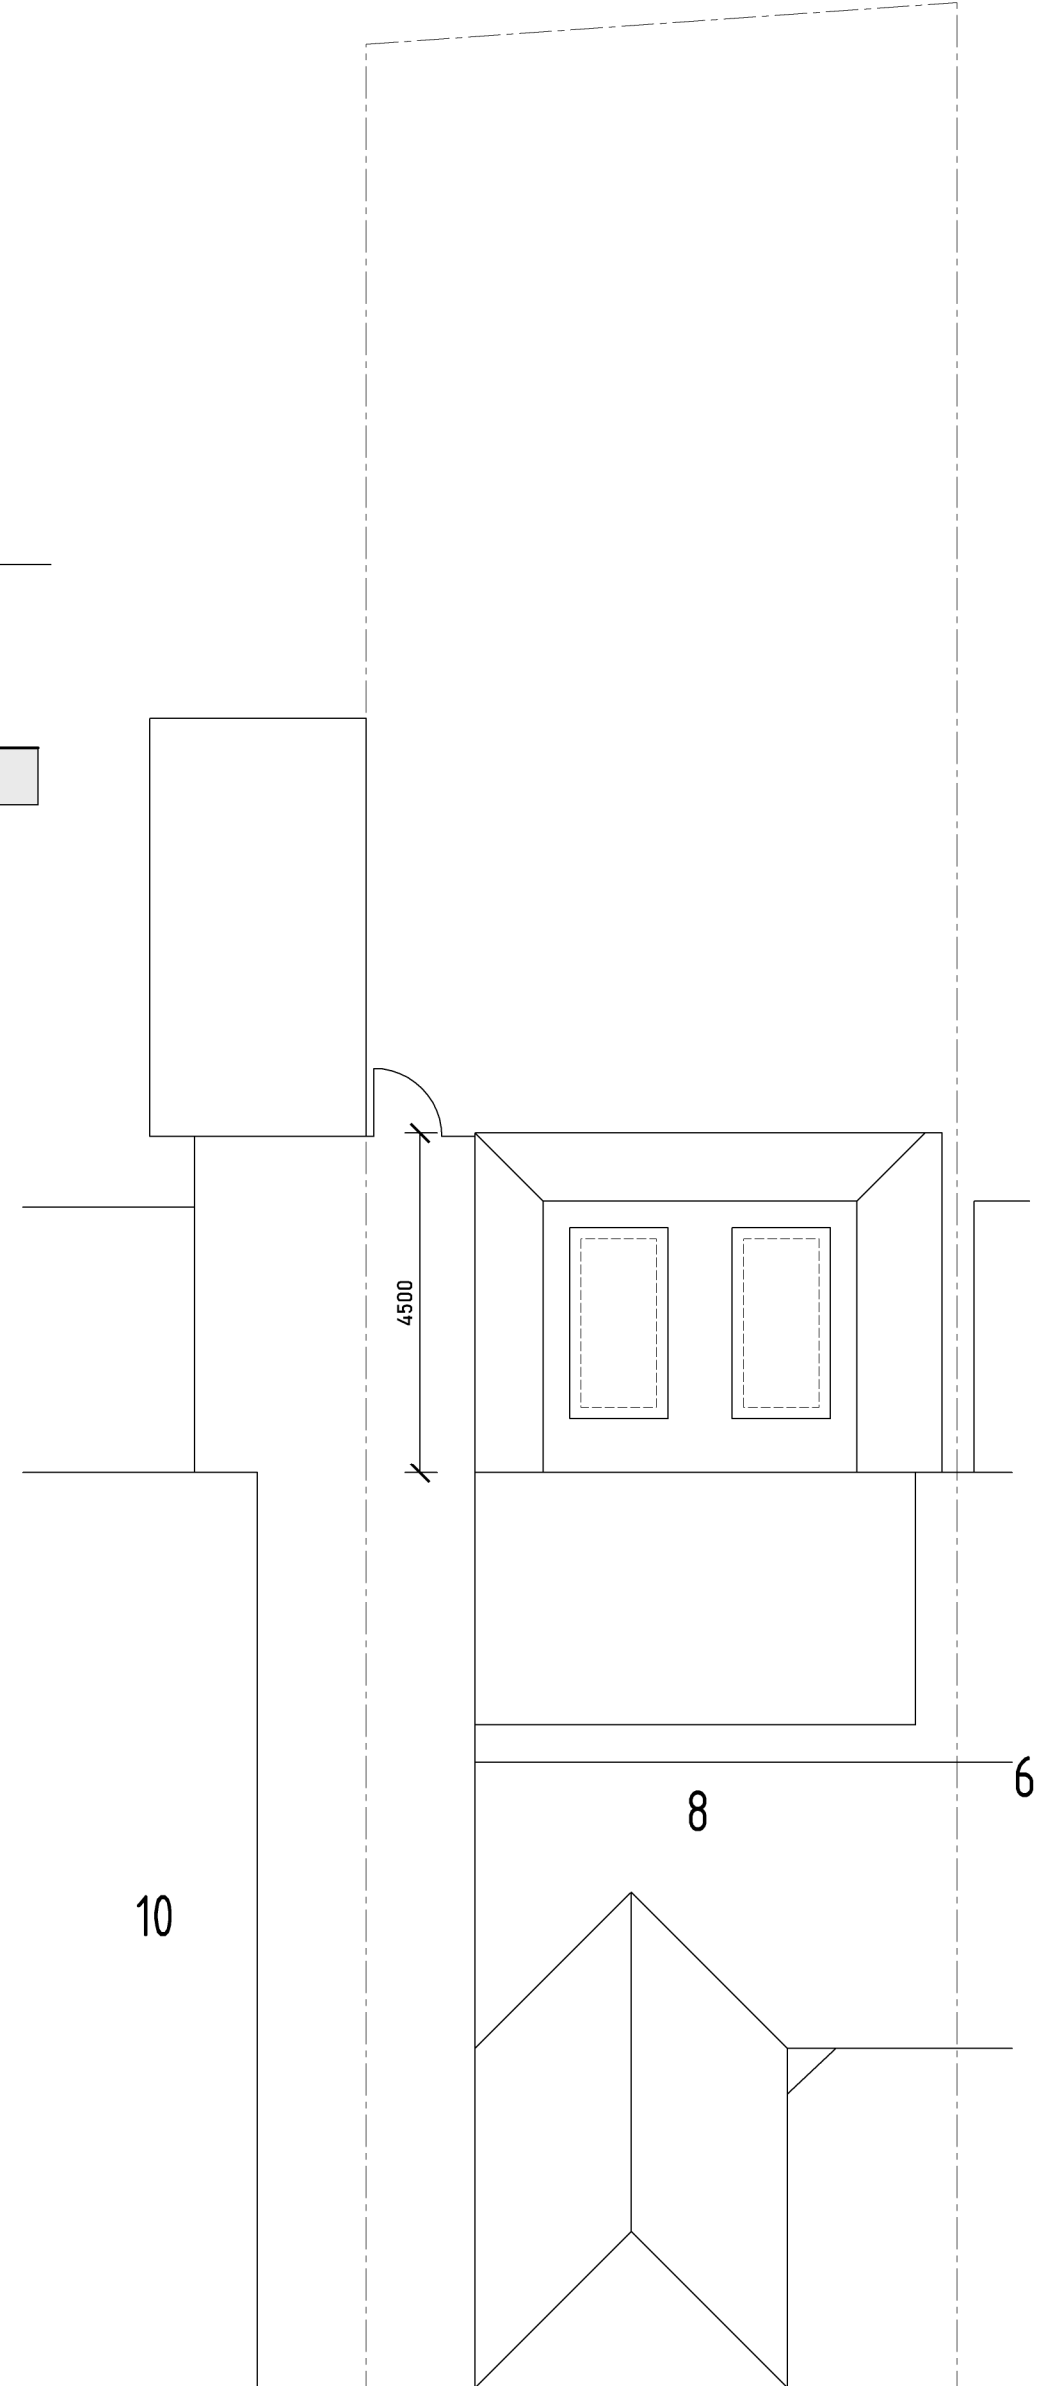

PROPOSED DWELLING
SITE LAYOUT PLAN

rev	date	info	drawn : SC/JD
scale: 1 : 100 / A1	date: 17 / 08 / 22	drw no: 599 / P2 / 1	
drawing:	PROPOSED EXTENSION FLOOR PLANS AND ELEVATIONS		
project:	8 WESTFIELD WAY RUISLIP, HA4 6HN		
client:	MISS J DEMEESTER		



MATERIALS TO BE SIMILAR IN APPEARANCE TO EXISTING
ROOFLIGHTS NOT TO PROTRUDE MORE THAN 150MM FROM ROOF SLOPE